2012 APPENDIX	B BUILDING COD	E SUMMARY		NC
Name Of Project: Address:		ITY REST AREA ST, MOREHEAD CITY,	NC	
Proposed Use: Dwner Or Authorized Agent:	RESTROOM BUIL Weeks Turner Arch	DING	hone: (919) 779-979	17
Owned By:	Raleigh, NC [] City/County	[] Private [-mail_ganderson@v X]State	
EAD DESIGN PROFES	,	[] County [TURNER ARCHIT	X] State	
ESIGNER	FIRM	NAME LIC. #	TELEPHONE	E-MAIL anderson@weeksturner.con
ivil lectrical: Burk		jamin E. Burke 22038		 benburke@nc.rr.com
re Alarm: umbing: Burk echanical: Burk		jamin E. Burke 22038 jamin E. Burke 22038		 benburke@nc.rr.com benburke@nc.rr.com
orinkler - Standpipe: ructural:	 			
etaining Walls > 5' High her:				
012 EDITION OF NC CC XISTING: [] Reconstructio			ddition [] Upfit [] Repair	
ONSTRUCTED	ORIGINAL USE REST	ROOMS		RESTROOMS
UILDING DATA				
CONSTRUCTION TYPE:] III-A [] IV [] V] III-B [X]		
MIXED CONSTRUCTION: SPRINKLERS:	[X]NO []YES [X]NO []PARTI	TYPES:	PA 13 [] NFP	A 13R [] NFPA 13D
STANDPIPES: FIRE DISTRICT:	[X]NO []YES	CLASS []I [] FLOOD HAZARD ARE	II []III []WET []DRY
BUILDING HEIGHT: MEZZANINE:	22 ft. median roof [X] NO [] YES		STORIES: 1	
) PORCH (SF)	TOTAL	NEW
3RD FLOOR 2ND FLOOR MEZZANINE	 150		 150	
1ST FLOOR BASEMENT	3,608 htd.	1,519	5,177	0
	3,608 htd.	1,519	5,327	0 SF
LLOWABLE AREA: RIMARY OCCUPANCY:				
] ASSEMBLY X] BUSINESS	[]A-1 []A-2 []A-	3 []A-4 []A-5		
] EDUCATIONAL] FACTORY-INDUSTRIAL] HIGH-HAZARD	[]F-1 Moderate	[]F-2 Low	H-3 Combust []H	-4 Health []H-5 HPM
] INSTITUTIONAL	[] -1 [] -2 [] -3] 2 2 3 3 4] 1 2 3 3 4		
] MERCANTILE] RESIDENTIAL] STORAGE	[]R-1 []R-2 []R- []S-1 Moderate	3 []R-4 []S-2 Low [
JUTILITY AND MISC	[] PARKING GARAG	ie[]OPEN [] ENCLOSED	[]REPAIR
SECONDARY OCCUPANCY SPECIAL OCCUPANCY:				409 [] 410 [] 411
	[]402 []403 []4	04 []405 []406 [14 []415 []416 []417 []418 []4	419 [] 420 [] 421
SPECIAL PROVISIONS:	[]508.2 []508.3	[]508.4 []508.5		508.7 []508.8
IIXED OCCUPANCY:] Incidental Use Separation		SEPARATION: HF	A. EXCEPTION:	-
This separtation is no	t exempt as a Non-Sepa	rated Use (see exception	ons)	
Limitations For Each	cupancy (508.3.2) f Construction For The B Of The Applicable Occup ermined, Shall Apply To	ancies To The Entire B	nined By Applying Th Building. The Most Re	ne Height And Area estrictive Type Of
] Separated Mixed Occupan For Each Story, The A	Area Of The Occupancy	Shall Be Such That The	Sum Of The Ratios	Of The Actual Floor Area
Of Each Use Divided ACTUAL AREA OF OCCUPA	By The Allowable Floor / NCY A + ACTU	Area For Each Use Sha JAL AREA OF OCCUP		
ALLOWABLE AREA OF OCC		WABLE AREA OF OC		
 A)	+	(C)	+ ≤ 1 (D) (E)	
STORY DESCR'N BLDĠ NO. AND USE PER S	STORY AREA		RINKLER AREA	OR BUILDING
1 BUSINESS 359	TUAL) 3 sf 9,000	6,750	REASE 2 UNLIMIT	0 31,500
	9,000	6.750	15,750	0 15,750
A. Perimeter Whic	reases From Section 50 h Fronts A Public Way O	r Open Space Having 2	s: 20 Ft Min. Width = 19	98 (F).
B. Total Building F C. Ratio (F/P) = 1 D. W= Minimum W	(F/P). /idth Of Public Way = 30) (W).		
E. Percent Of Fror 2. The Sprinkler Increas	ntage Increase IF = 100 [e Per Section 506.3 Is A	F/P - 0.25] X W/30 =	75 (%).	
A. Multi-story Build B. Single Story Bu 3 Unlimited Area Applic	ling Is = 200 % ilding Is = 300% able Under Conditions C)f Sections Group R E	M S A-4 (507).	
Group A Motion Pictu 4. Max. Building Area =	re (507.9); Malls (402.6) Total No. Of Stories In T	; And H-2 Aircraft Paint he Building X E But No	Hangers (507.7) It Greater Than 3 X E	E. (506.4)
5. The Maximum Area C Traffic Control Tower	Of Parking Garages Must s Must Comply With 412	Comply With 406.3.5. 1.2.	The Maximum Area	Ut Air
LLOWABLE HEIGHT				
YPE OF CONSTRUCTION:	TYPE VB ALLOWABLE	INCREASE	SHOWN	CODE
	(TABLE 503)	FOR SPRINKLERS	ON PLANS	REFERENCE
BUILDING HEIGHT IN FEET	40 (FT)	(H +20')	22 (FT)	

2012	APPEN	DIX B	BUILDII	NG
FIRE	PROTECTI	ON REQU	JIREMEN	ITS
BUILD	NING ELEMEN	Т	c c	FIRE SEP'I DIST.
STRU	CTURAL FRA	ME		(FT)
INCLU GIRD	JDING COLUN ERS, TRUSSE	INS		
	ING WALLS (TERIOR NORTH		MORI	Е ТН,
	EAST		MORI MORI MORI	E TH
	SOUTH NTERIOR		MORI	E TH.
AND I	BEARING WAL PARTITIONS XTERIOR	.LS		
	NORTH EAST			
IN	WEST SOUTH ITERIOR WAL	L & PARTI	TIONS	
FLOO IN	R CONSTRUC	CTION PPORTING		
ROOF	EAMS AND JC CONSTRUC CLUDING SU	TION		
BE SHAF	EAMS AND JC TS ENCLOSU	ISTS RES-EXIT		
CORF	TS ENCLOSU RIDOR SEPAR JPANCY SEPA	ATION	:R	
PART SMOP	Y/FIRE WALL	SEPARATIC SEPARATIC		
INCID	NT SEPARAT ENTAL USE S	SEPARATIC		
*	NDICATE SEC	CTION NO.	PERMITTI	NG F
	A FETY SYS ' ENCY LIGHTIN			
EXIT SIC FIRE AL	GNS:		[X] YES [X] YES [] YES	ין[] ין[] יע[X]
LIFE S	AFETY PLA	N REQU		TS
Life	Safety Plan Sh	eet #: A0.2		
[]		smoke rate and real pro		
[]		all opening a ructures with		•
[]	Occupancy	v types for e	each area a	
[X]	Exit access	oads for ea s travel dista	ances (101	,
[]		ath of trave engths (10 ⁻		; (101
[X] [X]		vidths for ea		
[X]	Actual occ	upant load f schematic	or each ex	it doo
	of occupan	cyseparatic	on	-
[]		f doors with f doors with		
[]		f doors with f doors equi		-
[]		f emergency e footage of		
[]	The square	e footage of ode excepti	each smo	ke co
DESIGN	LOADS: E	EXISTING T	O REMAIN	N - N
	ING OCCUPA	NCY CATE	GORY	
ROOF	LIVE LOAD			
FLOO	NG LIVE LOAE R LIVE LOAD R LIVE LOAD	(Uniform)		stora
SNOW	/ LOAD DATA		ieu)	
SNC	DUND SNOW I W EXPOSUR W LOAD IMP	E FACTOR		
THE FLA	RMAL FACTC	NR N LOAD	i no i oli	
	OF SLOPE FAC CHED ROOF S		D	
DES	LOAD DATA: IGN WIND SP	EED (ASCI	E 7-05)	
WIN	D IMPORTAN D EXPOSURE ERNAL PRESS			2
NBL B	D BASE SHEAD BASE SHEAD			,
COF	D BASE SHEA NER ZONE B	AR (y-y DIR OUNDARY	ECTION) DIST. "a"	FOR
PLU	JMBING FIX			
		JSINESS VATERCLO	-	F/100
RI		VALE FEI 2		INAL
PF	ROVIDED	4	6	2
AC	CESSIBLE	PARKING	EXIST	ing f
PA	l or Rking Area		OF SPACI PROVIDE	
TO	TAL			

NC DEPT. OF INSURANCE 2012 APPENDIX B building code summary CONTINUED							
FIRE PROTECTION REQUIREM	ENTS	LIFE \$	SAFETY PLAN	SHEET #	(IF PROVII	DED)	
BUILDING ELEMENT	FIRE SEP'N DIST. (FT)	RATING REQ'D	RATING PROV'D (W/* REDUCTION	DETAIL # AND SHEET #	DES. # FOR RATED ASS'Y	DES. # FOR RATED PENET'N	DES. # FOR RATED JOINTS
STRUCTURAL FRAME, INCLUDING COLUMNS GIRDERS, TRUSSES BEARING WALLS		0					
EXTERIOR NORTH MC	DRE THAN	30' 0					
	ORE THAN						
WEST MC	ORE THAN						
SOUTH MC	ORE THAN	30' 0					
INTERIOR NONBEARING WALLS AND PARTITIONS EXTERIOR							
NORTH							
EAST							
WEST							
SOUTH							
INTERIOR WALL & PARTITIONS							
FLOOR CONSTRUCTION INCLUDING SUPPORTING BEAMS AND JOISTS							
ROOF CONSTRUCTION INCLUDING SUPPORTING BEAMS AND JOISTS		0					
SHAFTS ENCLOSURES-EXIT							
SHAFTS ENCLOSURES-OTHER							
CORRIDOR SEPARATION							
OCCUPANCY SEPARATION							
PARTY/FIRE WALL SEPARATION							
SMOKE BARRIER SEPARATION							
TENANT SEPARATION INCIDENTAL USE SEPARATION							
*INDICATE SECTION NO. PERMI	TTING RED	UCTION					

[]YES [**X**]NO []YES [**X**]NO NO SMOKE DETECTION SYSTEMS: PANIC HARDWARE: 0V

(Chapter 7)

ons ect to distance to assumed property lines (705.8)

he proposed building

elates to occupant load calculation (Table 1004.1.1)

14.3 & 1028.8)

apacity each exit door can accommodate based on egress width (1005.1)

where fire rated floor/ceiling and/or roof structure is provided for purposes

(1008.1.10)

locks and the amount of delay (1008.1.9.7) c egress locks (1008.1.9.8)


open devices

ws (1029)


(902) ompartment (407.4)

tes that may have been utilized regarding the items above

NO CHANGES TO STRUCTURE

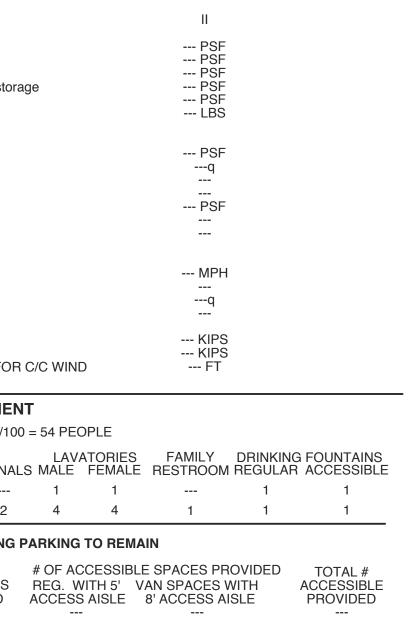

CARTERET COUNTY REST AREA 3409 ARENDELL ST MOREHEAD CITY, NORTH CAROLINA

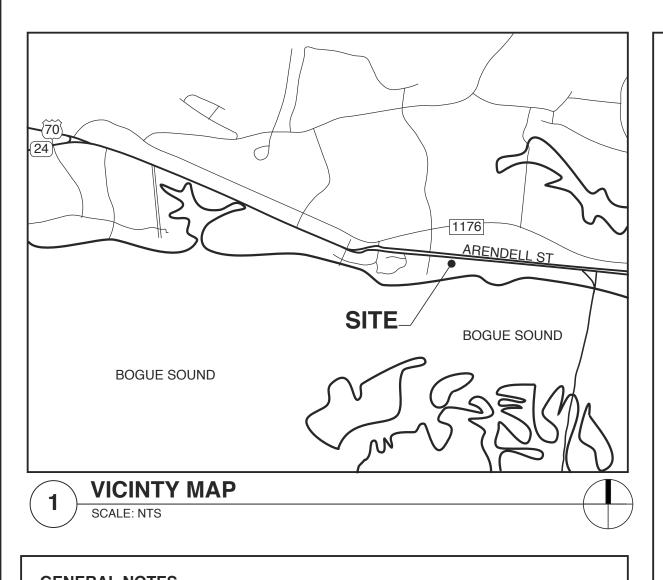

GENERAL NOTES

I: FOR THIS PROJECT: A) THE ARCHITECTS SCOPE OF WORK DOES INCLUDE CONSTRUCTION OBSERVATION. THE CONTRACTOR IS IN CHARGE OF THE WORK AND COMPLIANCE WITH THESE CONSTRUCTION DOCUMENTS IS THE SOLE RESPONSIBILITY OF THE CONTRACTOR. THE ARCHITECT WILL BEAR NO RESPONSIBILITY FOR FAILURE OF THE CONTRACTOR TO FULLY COMPLY WITH ALL CONSTRUCTION DOCUMENTS.

USE OF THESE CONTRACT DOCUMENTS WILL CONSTITUTE AGREEMENT BY THE CONTRACTOR TO THESE CONDITIONS.

B) "THE GENERAL CONDITIONS OF THE CONTRACT FOR THE CONSTRUCTION OF THE BUILDINGS" OF THE AMERICAN INSTITUTE OF ARCHITECTS DOCUMENT A-201, LATEST EDITION, ARE HEREBY MADE PART OF THE CONTRACT DOCUMENTS. IN THE EVENT OF A CONFLICT, THESE GENERAL NOTES AND CONTRACT SUPERSEDE "AIA DOCUMENT A-201" II: ALL WORK UNDER THIS CONTRACT SHALL:

A) CONFORM TO STATE, LOCAL AND NATIONAL CODES AND ORDINANCES AS ARE APPLICABLE TO THE WORK INCLUDING BUT NOT LIMITED TO THE NORTH CAROLINA STATE BUILDING CODE, THE AMERICANS WITH DISABILITIES ACT (ADA), NATIONAL ELECTRIC CODES. ASTM SPECIFICATIONS. AND OSHA SAFETY REGULATIONS.

B) COMPLY WITH ALL LAWS, ORDINANCES, CODES, RULES AND REGULATIONS PERTAINING TO ENVIRONMENTAL PROTECTION (EPA). THE COST OF ALL REQUIRED INSPECTIONS AND PERMITS SHALL BE THE RESPONSIBILITY OF THE CONTRACTOR.

III: UNLESS OTHERWISE DIRECTED BY THE ARCHITECT. THE CONTRACTOR SHALL:

WITH THE WORK. DO NOT SCALE DRAWINGS.

A) SUPPLY AND PAY FOR ALL LABOR, TRANSPORTATION, MATERIALS, TOOLS, APPARATUS, LÍGHTS, POWER, HEAT, SANITARY FÁCILITIES, WATER, SĆAFFOLDING, AND INCIDENTALS NECESSARY FOR THE COMPLETION OF HIS WORK.

B) INSTALL, MAINTAIN AND REMOVE ALL EQUIPMENT. OTHER UTENSILS OR THINGS USED FOR THE CONSTRUCTION PRIOR TO TURNING OVER THE PROJECT., IF SUCH ITEMS ARE LEFT AFTER COMPLETION OF THE PROJECT, THEY SHALL BECOME PROPERTY OF THE OWNER. THE OWNER MAY PROMPTLY DISPOSE OF SUCH ITEMS, AND WILL NOT BE SUBJECT TO CLAIMS OF THE CONTRACTOR RESULTING FROM SUCH DISPOSITION.

C) CONSTRUCT IN THE BEST AND PROFESSIONAL MANNER, A COMPLETE JOB AND VERYTHING INCIDENTAL THERETO, AS SHOWN OR REASONABLY IMPLIED FROM THE PLANS, ALL WORK SHALL BE COMPLETED IN ACCORDANCE WITH THE CONTRACT DOCUMENTS.

D) VERIFY ALL DIMENSIONS AND CONDITIONS PRIOR TO PROCEEDING WITH THE WORK AND NOTIFY THE ARCHITECT IN WRITING OF ANY DISCREPANCIES DISCOVERED OR LACK OF REQUIRED INFORMATION TO REQUEST CLARIFICATION. IF THE CONTRACTOR OBSERVES THE CONTRACT DOCUMENTS TO BE CONTRARY TO GOVERNING LAWS, ORDINANCES, CODES, RULES AND REGULATIONS OR OTHERWISE QUESTIONABLE CONDITIONS, HE SHALL PROMPTLY NOTIFY THE ARCHITECT IN WRITING FOR INSTRUCTIONS PRIOR TO PROCEEDING

E) KEEP THE BUILDING AND SURROUNDING AREA REASONABLY FREE FROM RUBBISH AT ALL IMES. AT A MINIMUM, DEBRIS SHALL BE REMOVED FROM THE SITE ON A WEEKLY BASIS OR AS DIRECTED BY PROJECT EXPEDITOR.

F) LOCATE ALL EXISTING UTILITIES. THE CONTRACTOR MAY NOT INTERFERE WITH ADJACENT UTILITIES UNLESS PRIOR NOTICE AND PERMISSION IS RECEIVED FROM THOSE WHO MAY AS A RESULT OF THIS INTERFERENCE BE AFFECTED.

G) PRIOR TO ANY WORK, CALL "NC ONE CALL CENTER" @ 800-632-4949 AND OTHER LÓCATING SERVICES AS TO CONFIRM LOCATION OF UTILITIES.

H) PRIOR TO FINAL INSPECTION AND ACCEPTANCE OF THE BUILDING, EACH CONTRACTOR SHALL CLEAN HIS PORTION OF THE WORK, INCLUDING GLASS, HARDWARE FIXTURES, MASONRY, TILE AND MARBLE (USING NO ACID), CLEAN AND WAX ALL FLOORS AS SPECIFIED, AND COMPLETELY PREPARE THE BUILDING FOR USE BY THE OWNER.

I) FILE WITH THE OWNER CURRENT INSURANCE CERTIFICATIONS IN THE AMOUNTS REQUESTED BY THE OWNER FOR BUILDER'S RISK, WORKMEN'S COMPENSATION, COMPREHENSIVE GENERAL LIABILITY, BODILY INJÚRY AND PROPERTY DAMAGE. THIS INSURANCE SHALL INDEMNIFY THE OWNER AND THE ARCHITECT OF ANY AND ALL COSTS, CLAIMS, SUITS AND JUDGEMENTS FOR PROPERTY DAMAGE AND PERSONAL INJURY INCLUDING GENERAL) ARISING OUT OF THE CONTRACTOR'S ACTIONS.

J) PROVIDE ALL NECESSARY SAFETY MEASURES FOR THE PROTECTION OF ALL PERSONS OF THE WORK, INCLUDING THE REQUIREMENTS OF THE A.G.C. ACCIDENT PREVENTION MANUAL IN CONSTRUCTION AS AMENDED, AND SHALL FULLY COMPLY WITH ALL STATE LAWS OR REGULATIONS AND NORTH CAROLINA STATE BUILDING CODE REQUIREMENTS TO PREVENT ACCIDENT OR INJURY TO PERSONS ON OR ABOUT THE LOCATION OF THE WORK. K) CLEARLY MARK OR POST SIGNS WARNING OF HAZARDS EXISTING, AND BARRICADE

EXCAVATIONS, ELEVATOR SHAFTS, STAIRWELLS AND SIMILAR HAZARDS. PROTECT AGAINST DAMÁGE OR INJURY RESÚLTING FROM FALLING MATERIALS AND MAINTAIN ALL PROTECTIVE DEVICES AND SIGNS THROUGHOUT THE PROGRESS OF THE WORK

ENERGY SUMMARY

Method | Presc] Perfoi

Roof/cei CONSTR

Exterior

Walls ad

Walls be

Floors o

Slab heated

Floors s

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DRAWING INDEX

A0.1	COVER SHEET
A0.2	LIFE SAFETY PLAN
A0.3	SITE PLAN
A1.1	EXIST. FLOOR PLAN-DEMO
A1.2	REV. FLOOR PLAN
A1.3	RCP & ROOF PLAN
A1.4	FINISH PLAN
A1.5	INT. ELEVATIONS & DETAILS
A1.6	DETAILS
A1.7	TILE FLOOR, KEY PLAN, NOTES
A1.8	TILE WALL ELEVATIONS
A1.9	TILE LEGENDS
A1.10	TILE DETAIL ELEVATIONS
A1.11	ARTWORK TILE ALT. 1
A1.12	ARTWORK TILE ALT. 2 & 3
A2	ELEVATIONS
A3	SECTIONS
A4	SCHEDULES & DETAILS
A5	STORAGE SHED
P1	PLUMBING SPECIFICATIONS
P2	EXISTING DEMO PLUMBING PLAN
P3	REVISED DWV PLAN
P4	REVISED SUPPLY PLAN
M1	HVAC SCHUDULES
M2	HVAC PLAN
M3	HVAC DETAILS
E1	ELECTRICAL DETAILS/SPECS
E2	EXISTING LIGHTING PLAN
E3	REVISED LIGHTING PLAN
E4	EXISTING POWER PLAN
E5	REVISED POWER PLAN
E6	PANEL SCHEDULES/SERIVCE RISER
E7	LIGHTING CONTROL DETAILS

ENERGY REQUIREMENTS:

The following data shall be considered minimum and any special attribute required to meet the energy code shall also be provided. Each Designer shall furnish the required portions of the project information for the plan data sheet. If energy cost budget method, state the annual energy cost budget vs allowable annual energy cost budget.

THERMAL ENVELOPF


MAL ENVELOPE
o d of Compliance: escriptive % Glazed Wall Area formance [] Energy Cost Budget
ceiling Assembly (each assembly) Description of assembly REPLACE WHERE EXPOSED DURING TRUCTION WITH R-38 batt insulation at attic floor U-Value of total assembly R-Value of insulation Skylights in each assembly U-Value of skylight Total square footage of skylights in each assembly
Total square footage of skylights in each assembly
or Walls (each assembly) Description of assembly U-Value of total assembly R-Value of insulation Openings (windows or doors with glazing)
U-Value of assembly 0.32 Shading coefficient 0.33 Projection factor 0.40 Low-e required, if applicable
adjacent to unconditioned space (each assembly) Description of assembly na U-Value of total assembly
Door R-Values
below grade (each assembly) Description of assembly na U-Value of total assembly
s over unconditioned space (each assembly) Description of assembly 2x10s, new R-30 batt insulation U-Value of total assembly
s slab on grade (each assembly) Description of assembly <u>na</u> U-Value of total assembly R-Value of insulation Horizontal/Vertical requirement

STATE ID#: 17-17533-01A WBS ELEMENT: 51213.031

PROJECT TITLE **CARTERET COUNTY REST AREA** 3409 ARENDELL STREET


MOREHEAD CITY, NORTH CAROLINA

PROJECT NO. 1604a DRAWING TITLE **COVER SHEET**

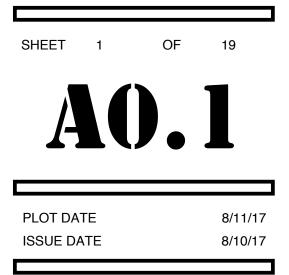

This original sheet is 22" x 34"; other dimensions indicate it has been altered

AREAS			
1,449 SF	EXISTING REST AREA		
2,144 SF	EXISTING VISITOR CENTER		
2,339 SF	EXISTING PORCH AREA		
5,932 SF	TOTAL AREA		

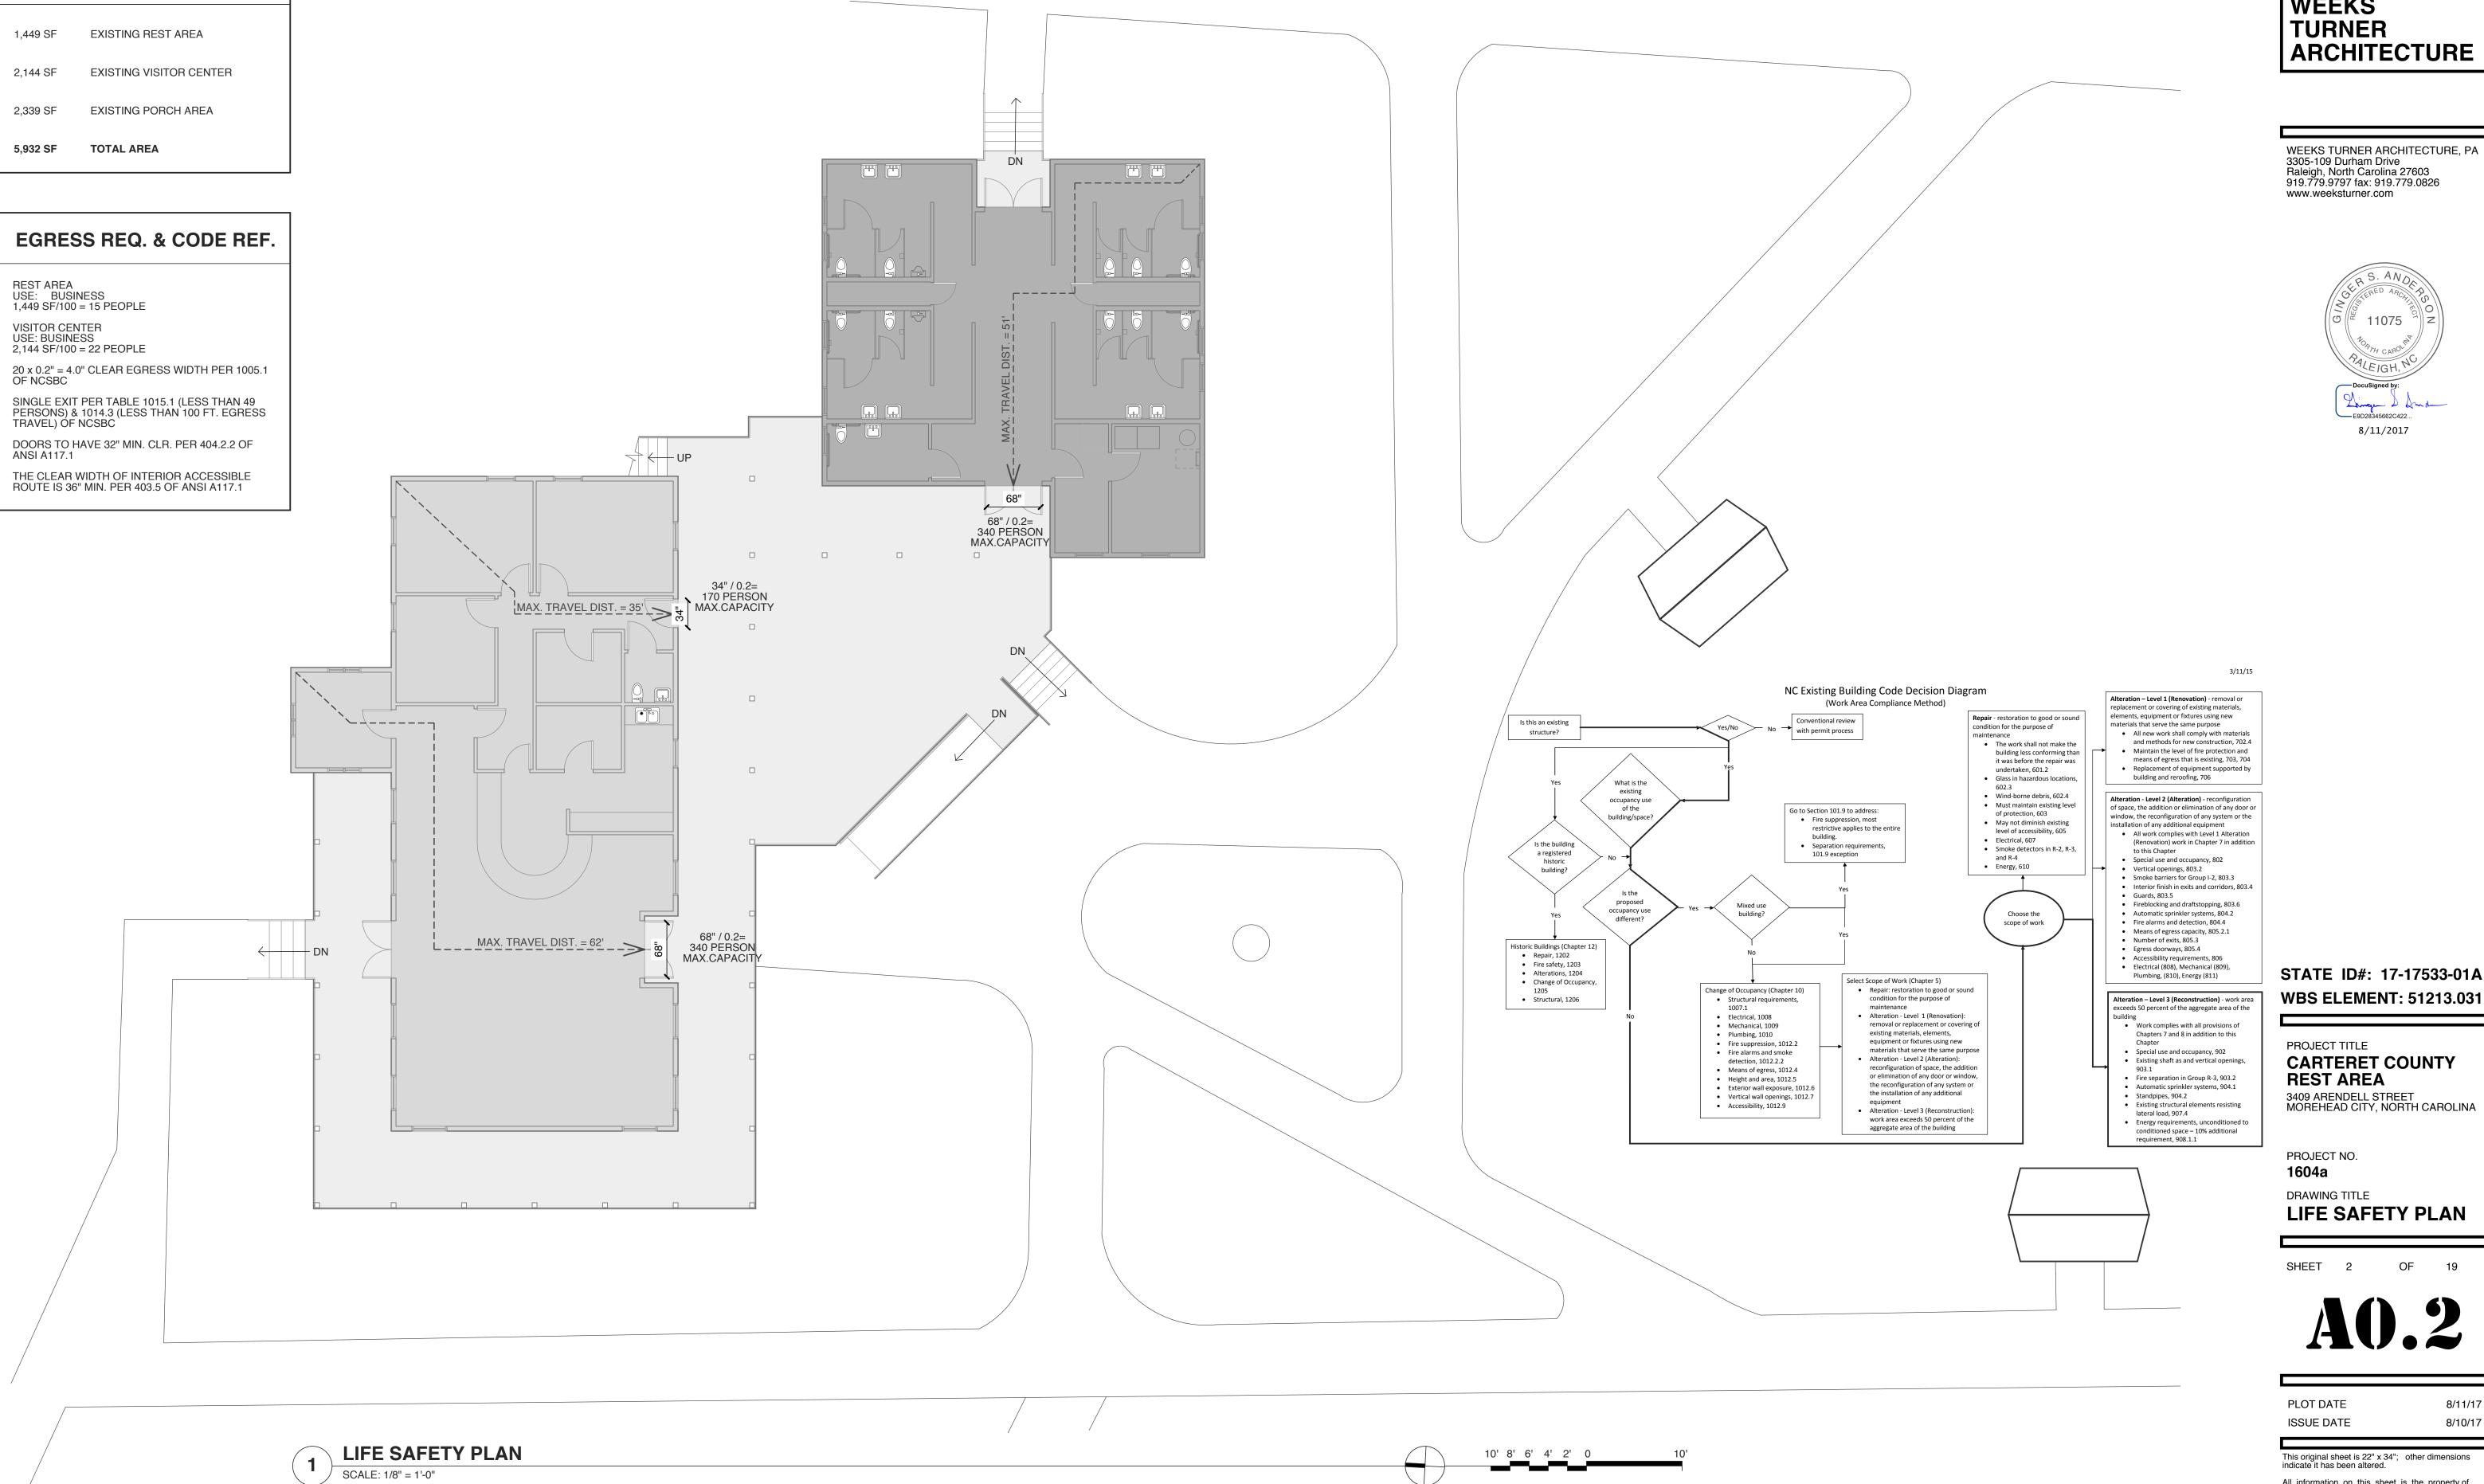



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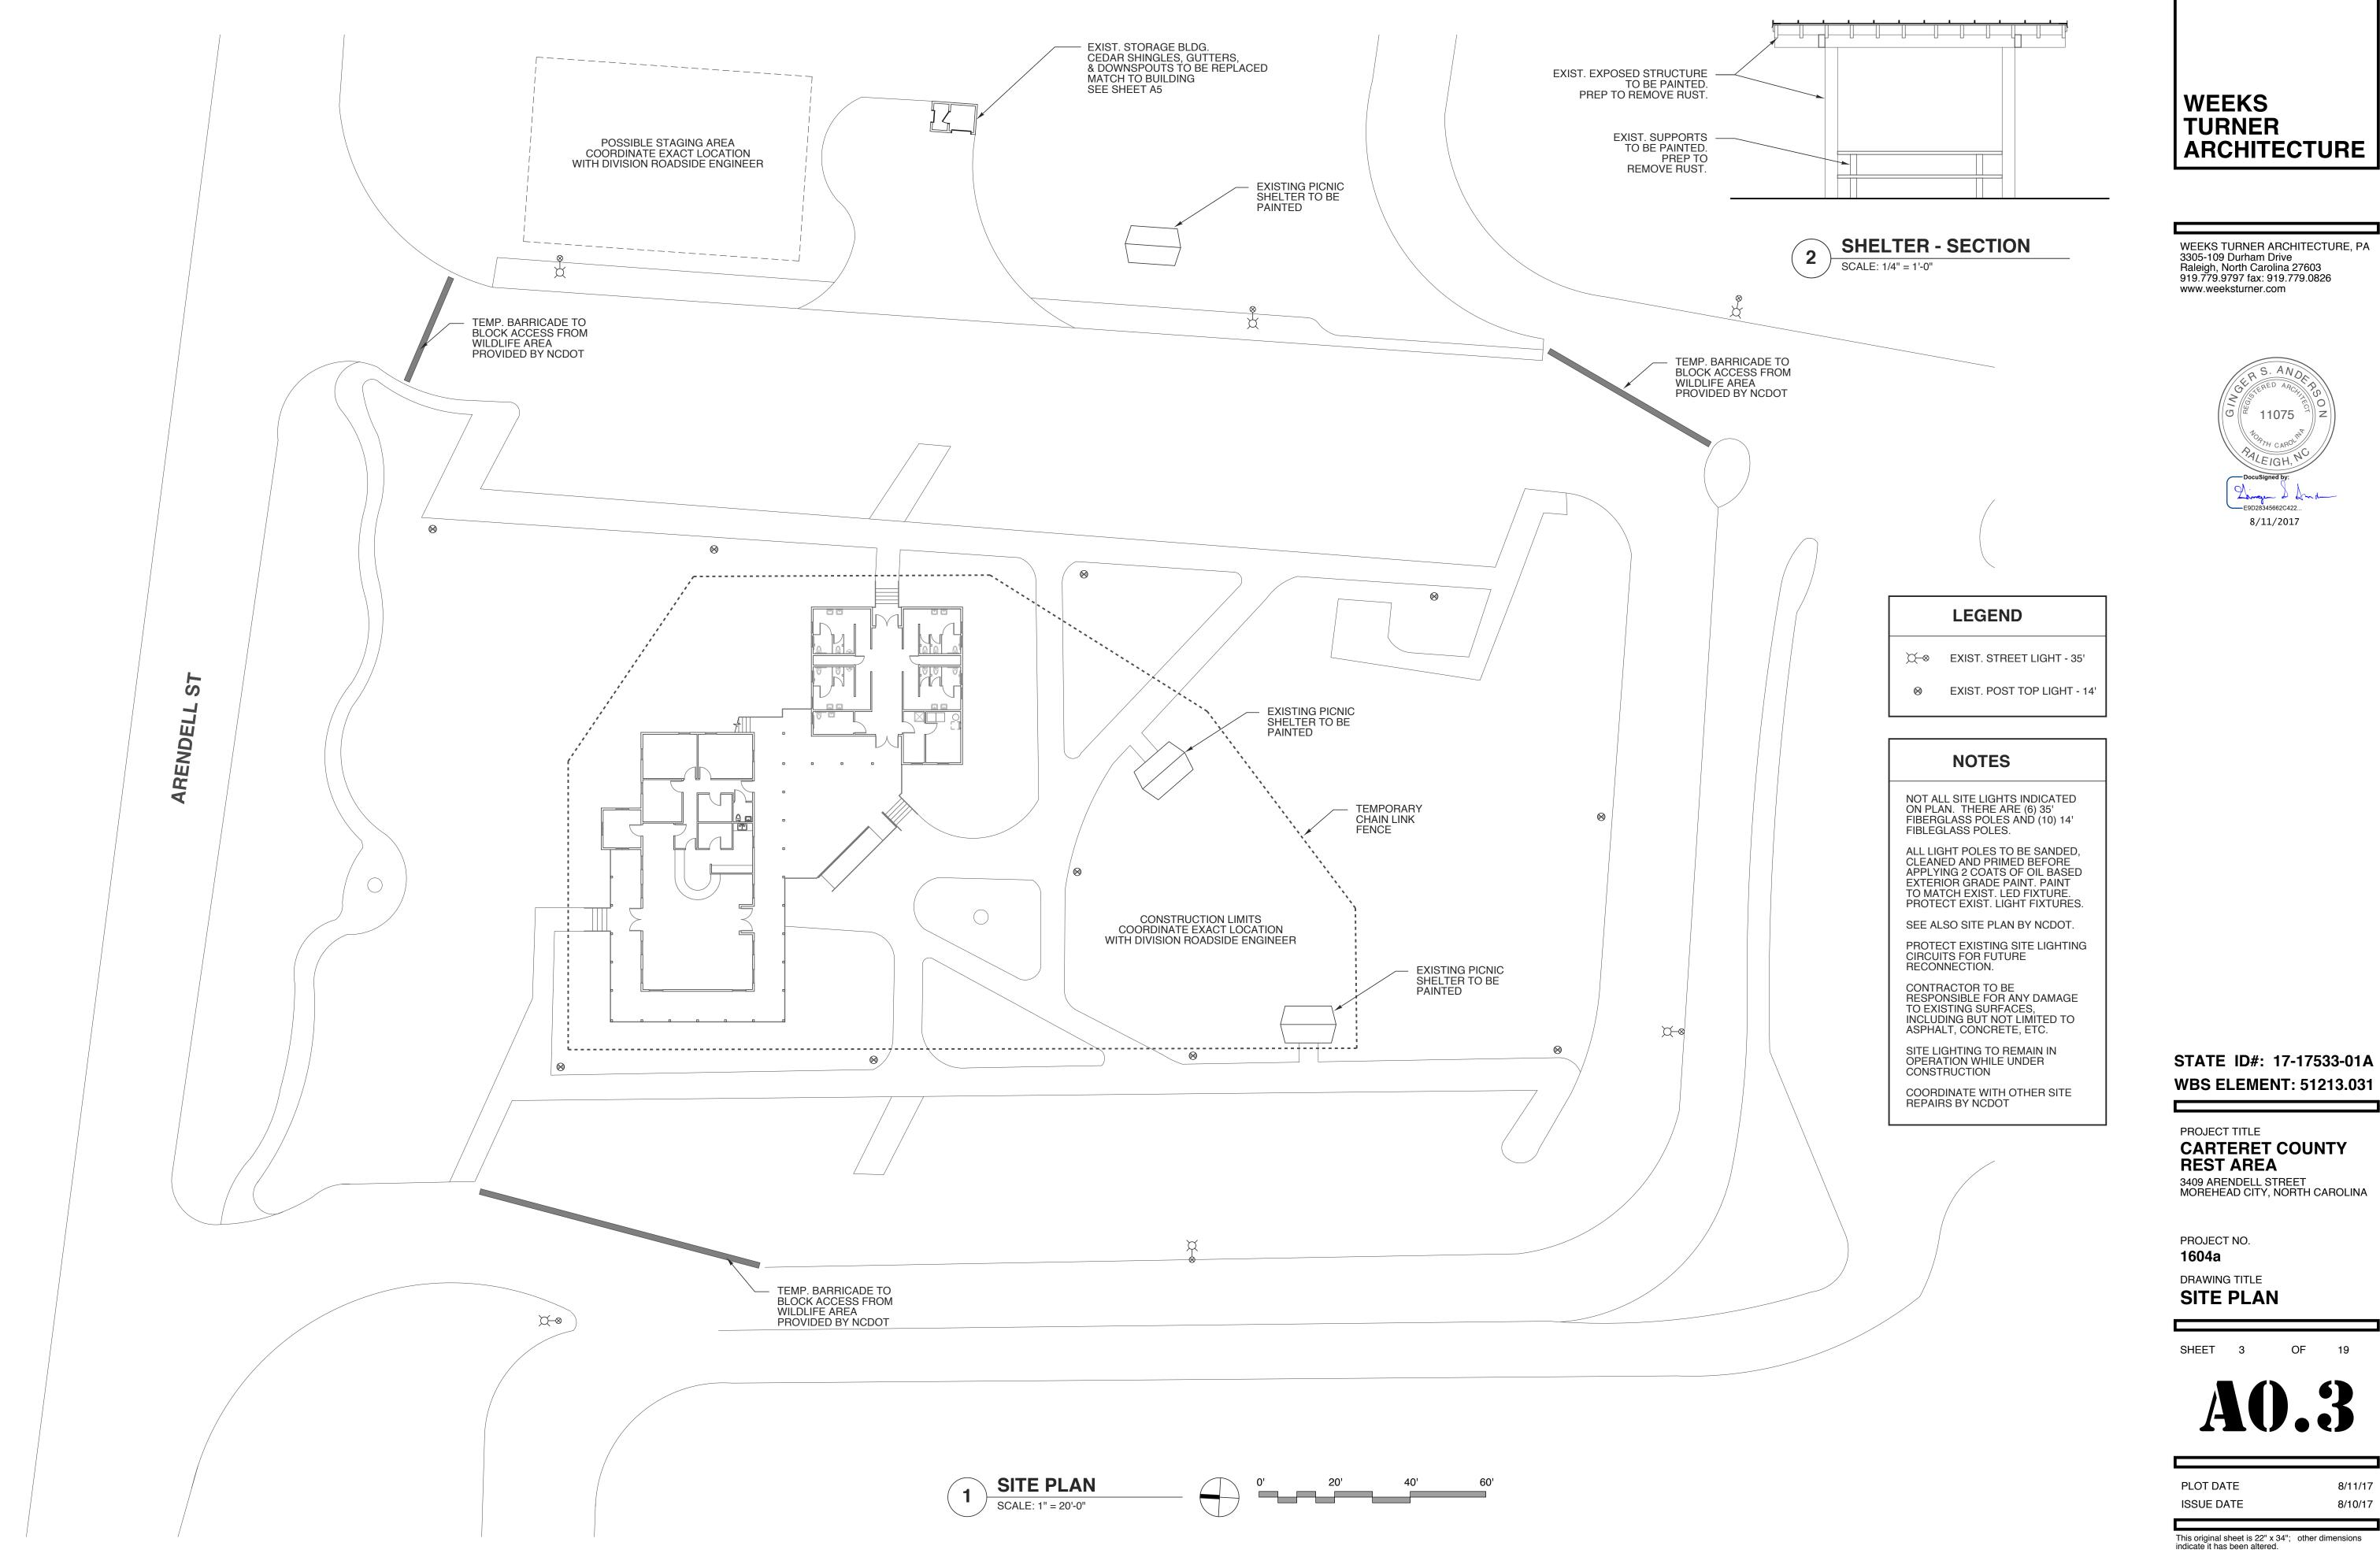


This original sheet is 22" x 34"; other dimensions indicate it has been altered.

19

8/11/17

8/10/17



PLOT DATE	8/11/17
ISSUE DATE	8/10/17

This original sheet is 22" x 34"; other dimensions indicate it has been altered.

NOTES

-REPLACE EXISTING WINDOWS WITH HIGH WIND RESISTANT PICTURE WINDOWS -REPLACE CEDAR SHAKE SIDING WITH FIBER CEMENT SHAKES -REFLASH DORMERS AS NEEDED

-REPLACE GUTTERS AND DOWNSPOUTS. NEW GUTTERS TO BE SEAMLESS

-REPLACE ALL DECKING, RAILS, & PICKETS WITH COMPOSITE PRODUCT

LAYOUT TO REMAIN THE SAME -EXISTING EXTERIOR POST TO REMAIN

-NEW PORCH AND SOFFIT LIGHTS (T&G CEILING TO REMAIN)

-REPLACE EXTERIOR DOORS, INCLUDING HC PUSH BUTTON OPERATOR

-REMOVE ALL FIRE ALARM AND SPRINKLER COMPONENTS AND REPAIR FINISHED BEHIND

-NEW REST AREA HVAC WITH REVISED INTAKE & EXHAUST -NEW LED LIGHTING -NEW INTERIOR FINISHES -INSULATED CHASE IN CRAWL FOR PIPING TO PREVENT FREEZING -NEW PLUMBING FIXTURES -ADDED WATER FOUNTAIN

DEMOLITION & CONSTRUCTION NOTES


ALL MATERIALS SHALL BE NEW AND OF QUANTITY SPECIFIED, EXCEPT WHERE RECLAIMED MATERIAL IS INDICATED FOR USE. WORKMANSHIP SHALL AT ALL TIMES BE OF A GRADE ACCEPTED AS THE BEST PRACTICE OF THE PARTICULAR TRADE INVOLVED, AND AS STIPULATED IN WRITTEN STANDARDS OF RECOGNISED ORGANIZATIONS OR INSTITUTES OF THE RESPECTIVE TRADES EXCEPT AS EXCEEDED OR QUALIFIED BY THE SPECIFICATIONS.


ITEMS RESULTING FROM THE DEMOLITION AND ITEMS WHICH ARE NOT TO BE RETURNED TO THE OWNER AS NOTED HEREIN, SHALL BE REMOVED FROM THE SITE, AS THE WORK PROGRESSES, AND DISPOSED OF IN A LEGAL MANER. .


THE CONTRACTOR SHALL REVIEW EACH PHASE OF THE WORK PRIOR TO PROCEEDING WITH THE WORK AND SHALL NOTIFY THE ARCHITECT IN WRITING OF ANY DISCREPANCIES IN THE CONTRACT DOCUMENTS THAT WILL RESULT IN CHANGES TO THE WORK.

AREA OUTSIDE OF AREA OF WORK TO REMAIN CLEAR AND CLEAN OF DEBRIS, EQUIPMENT ETC. AT ALL TIMES..

	WALL LEGEND
	EXIST. EXTERIOR WALL TO REMAIN
	EXIST. INTERIOR WALL TO REMAIN
<u> </u>	EXIST. 1 HR. RATED WALL TO REMAIN
	TO BE REMOVED

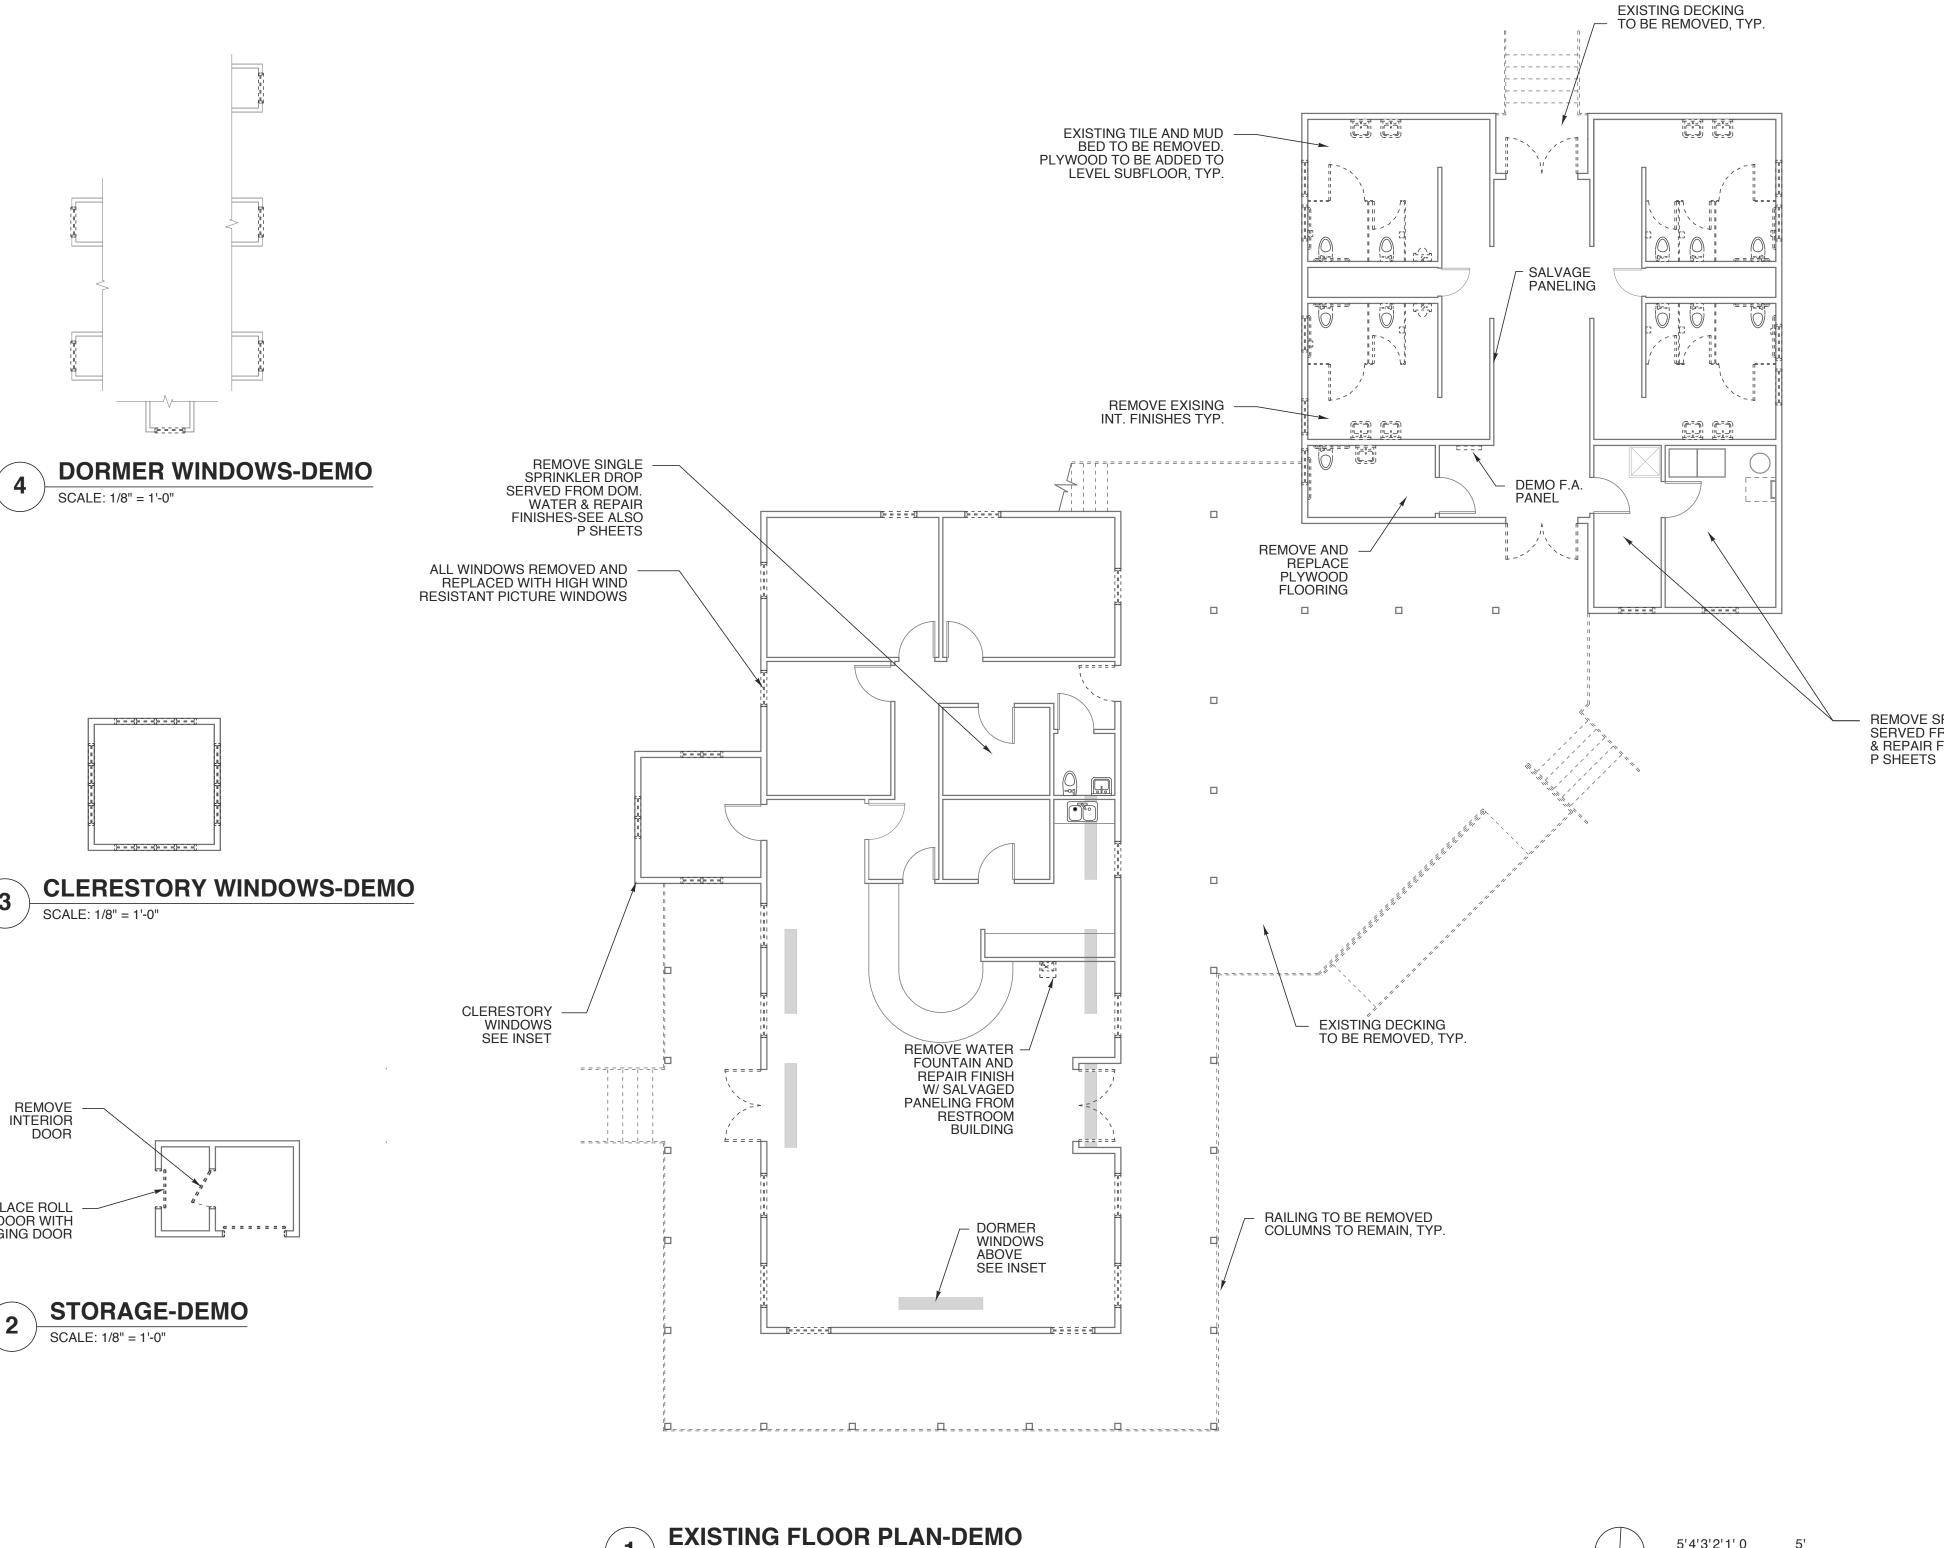


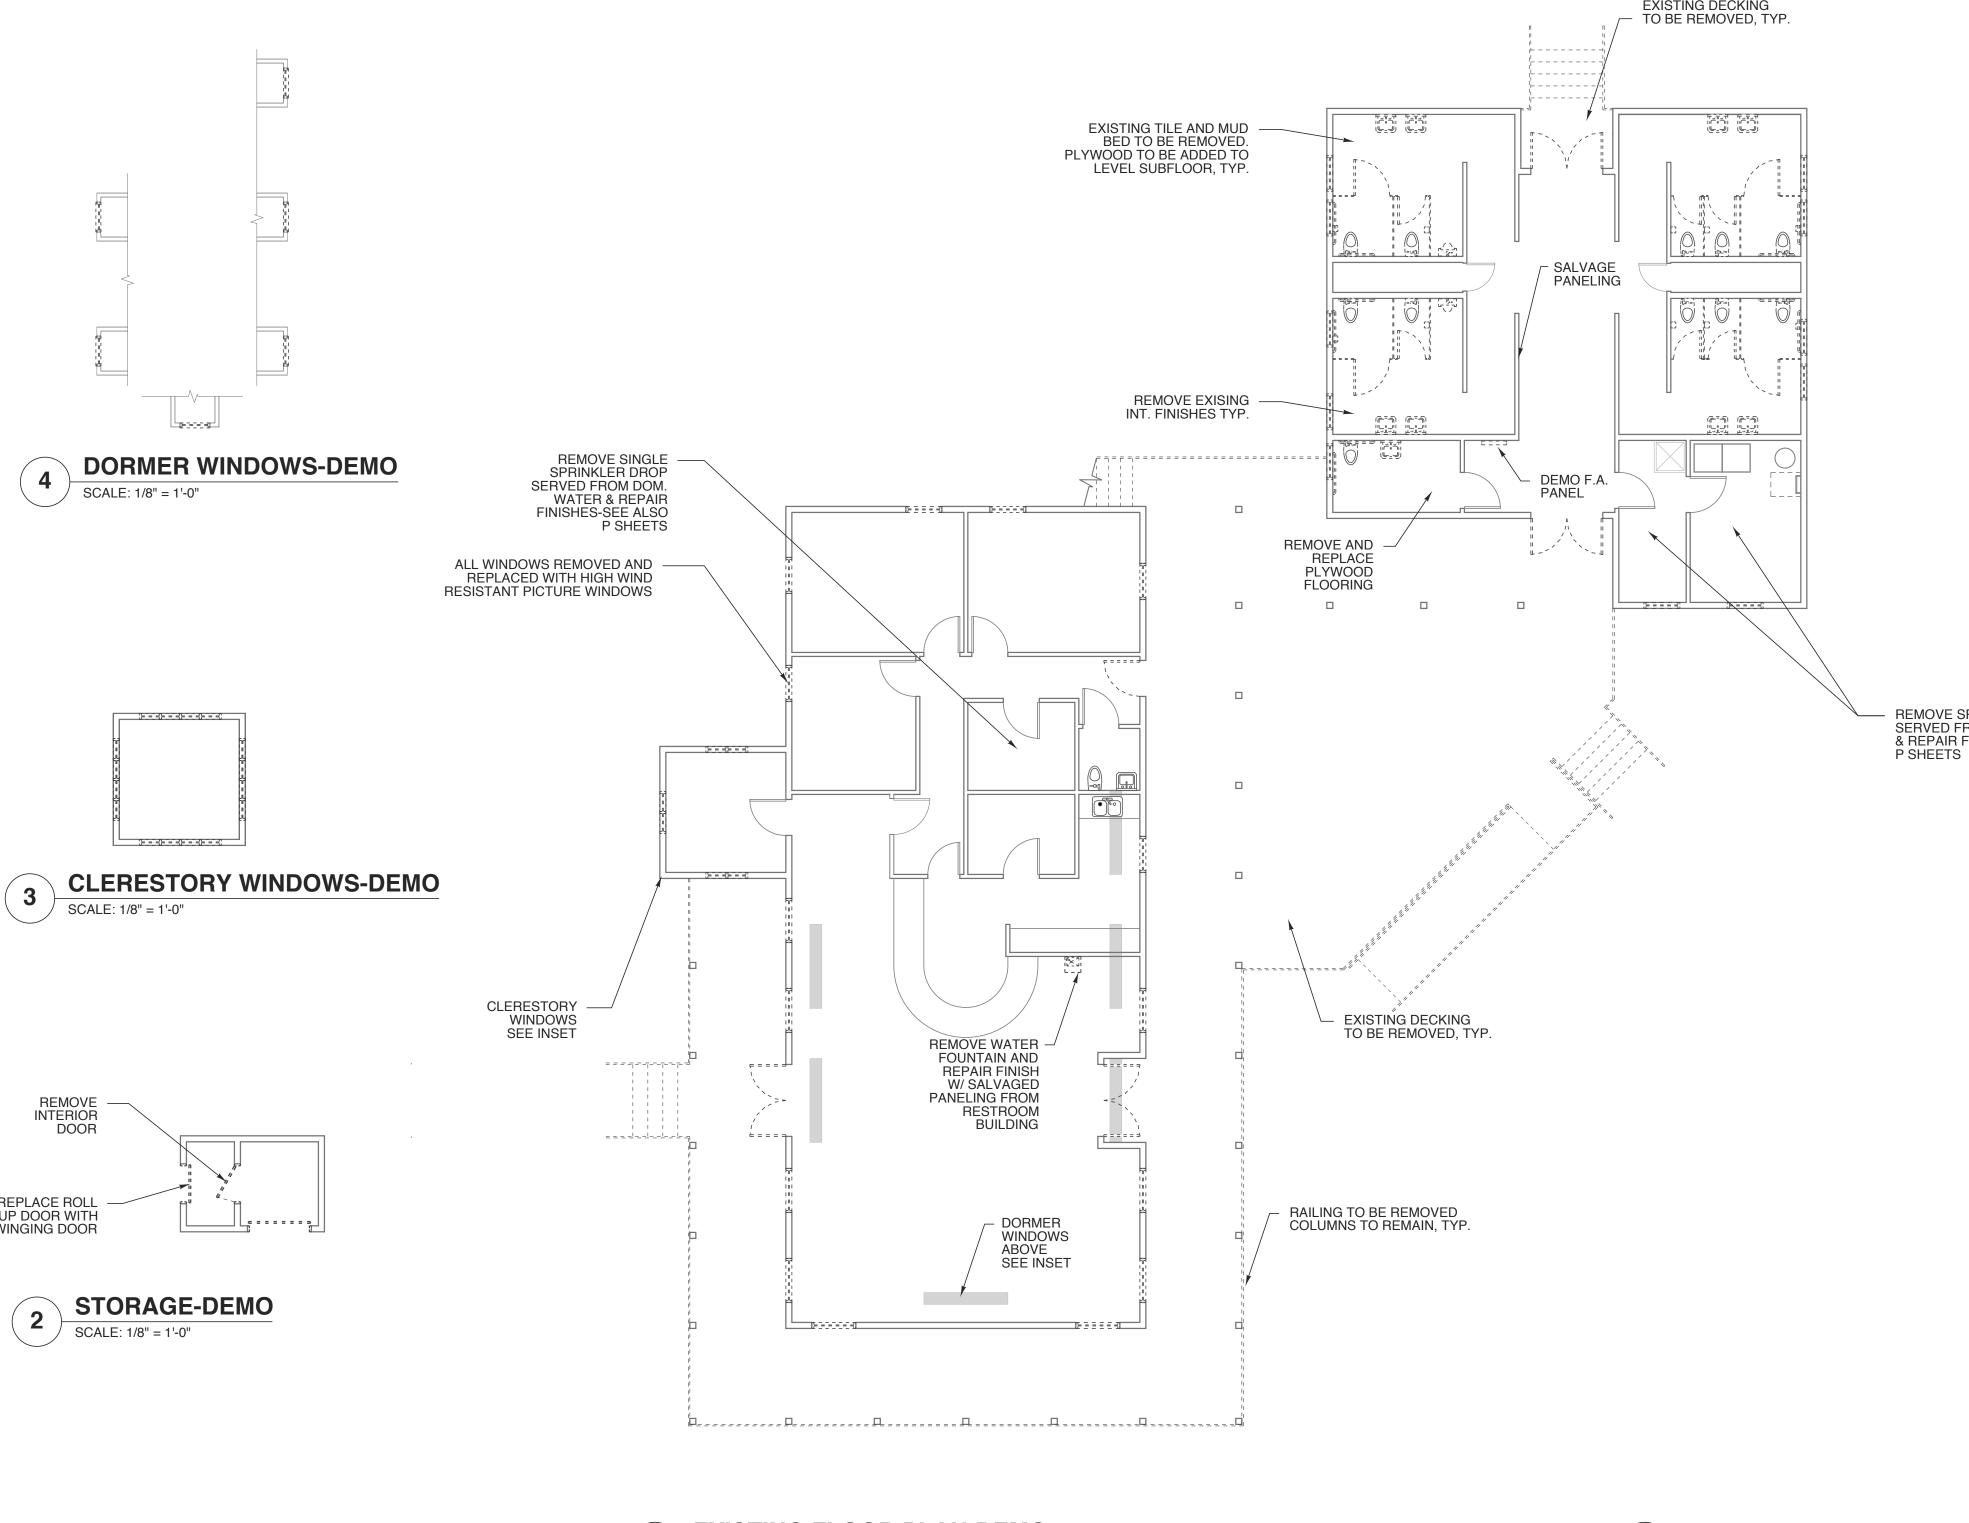

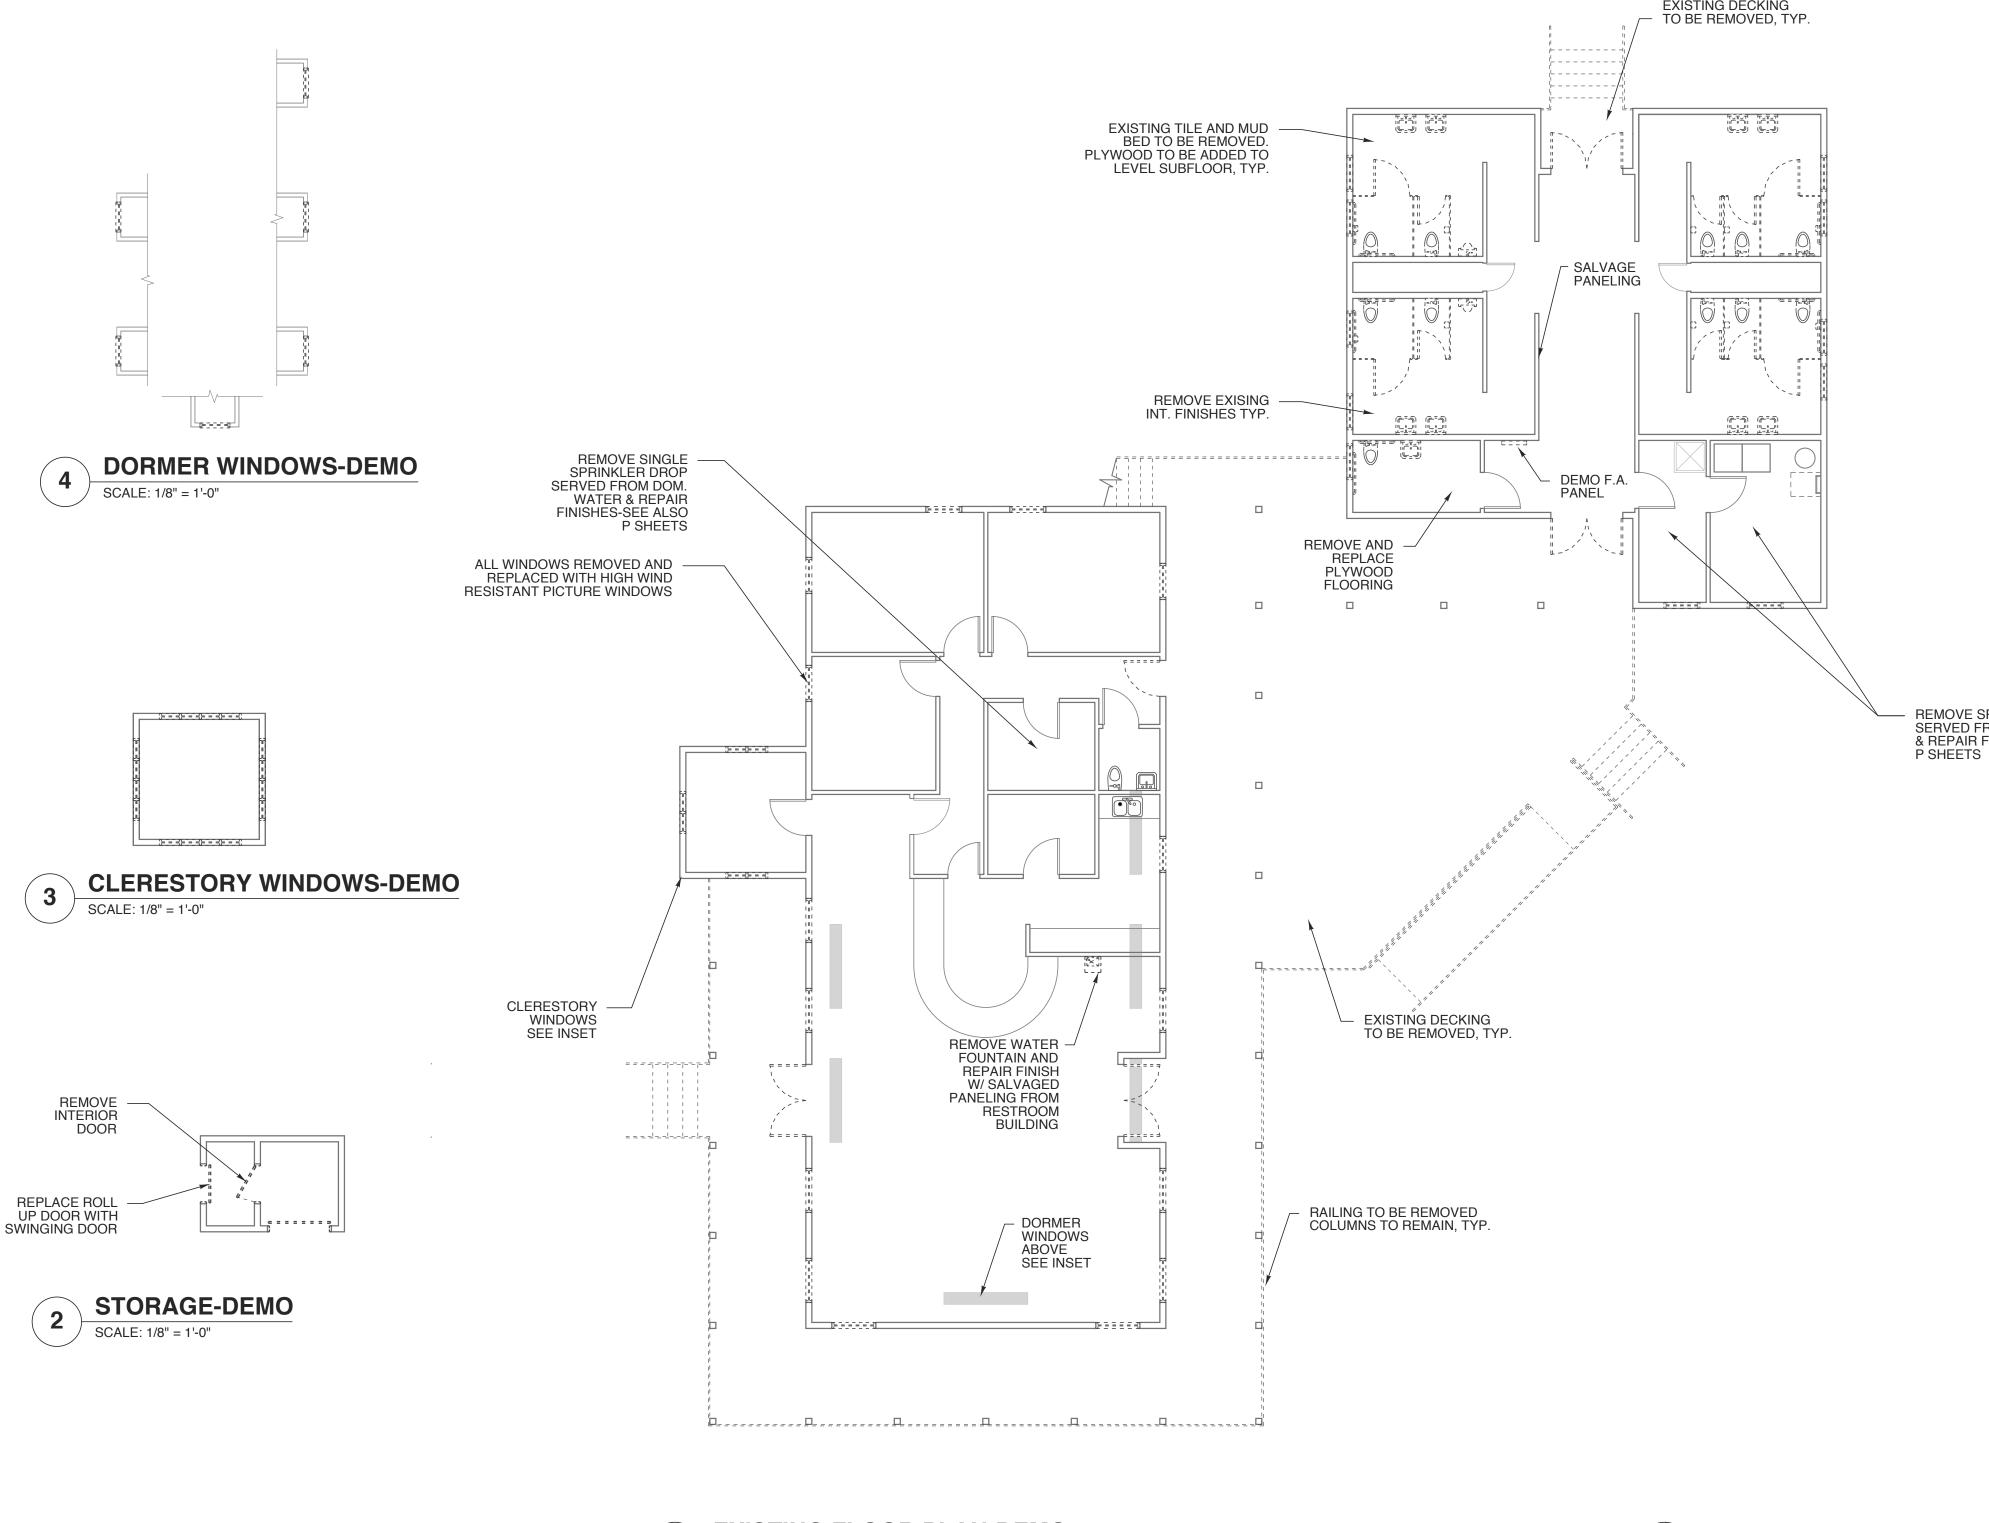



SCALE: 1/8" = 1'-0"

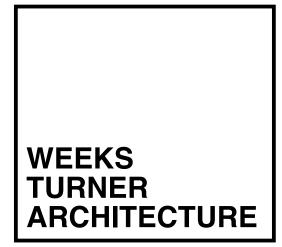

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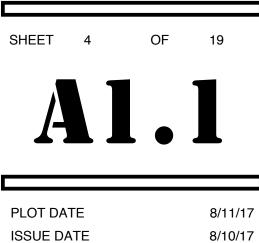


REMOVE SPRINKLER DROPS SERVED FROM DOM. WATER & REPAIR FINISHES-SEE ALSO

STATE ID#: 17-17533-01A WBS ELEMENT: 51213.031


PROJECT TITLE **CARTERET COUNTY REST AREA** 3409 ARENDELL STREET MOREHEAD CITY, NORTH CAROLINA

PROJECT NO. 1604a DRAWING TITLE **DEMO PLAN**




8/10/17


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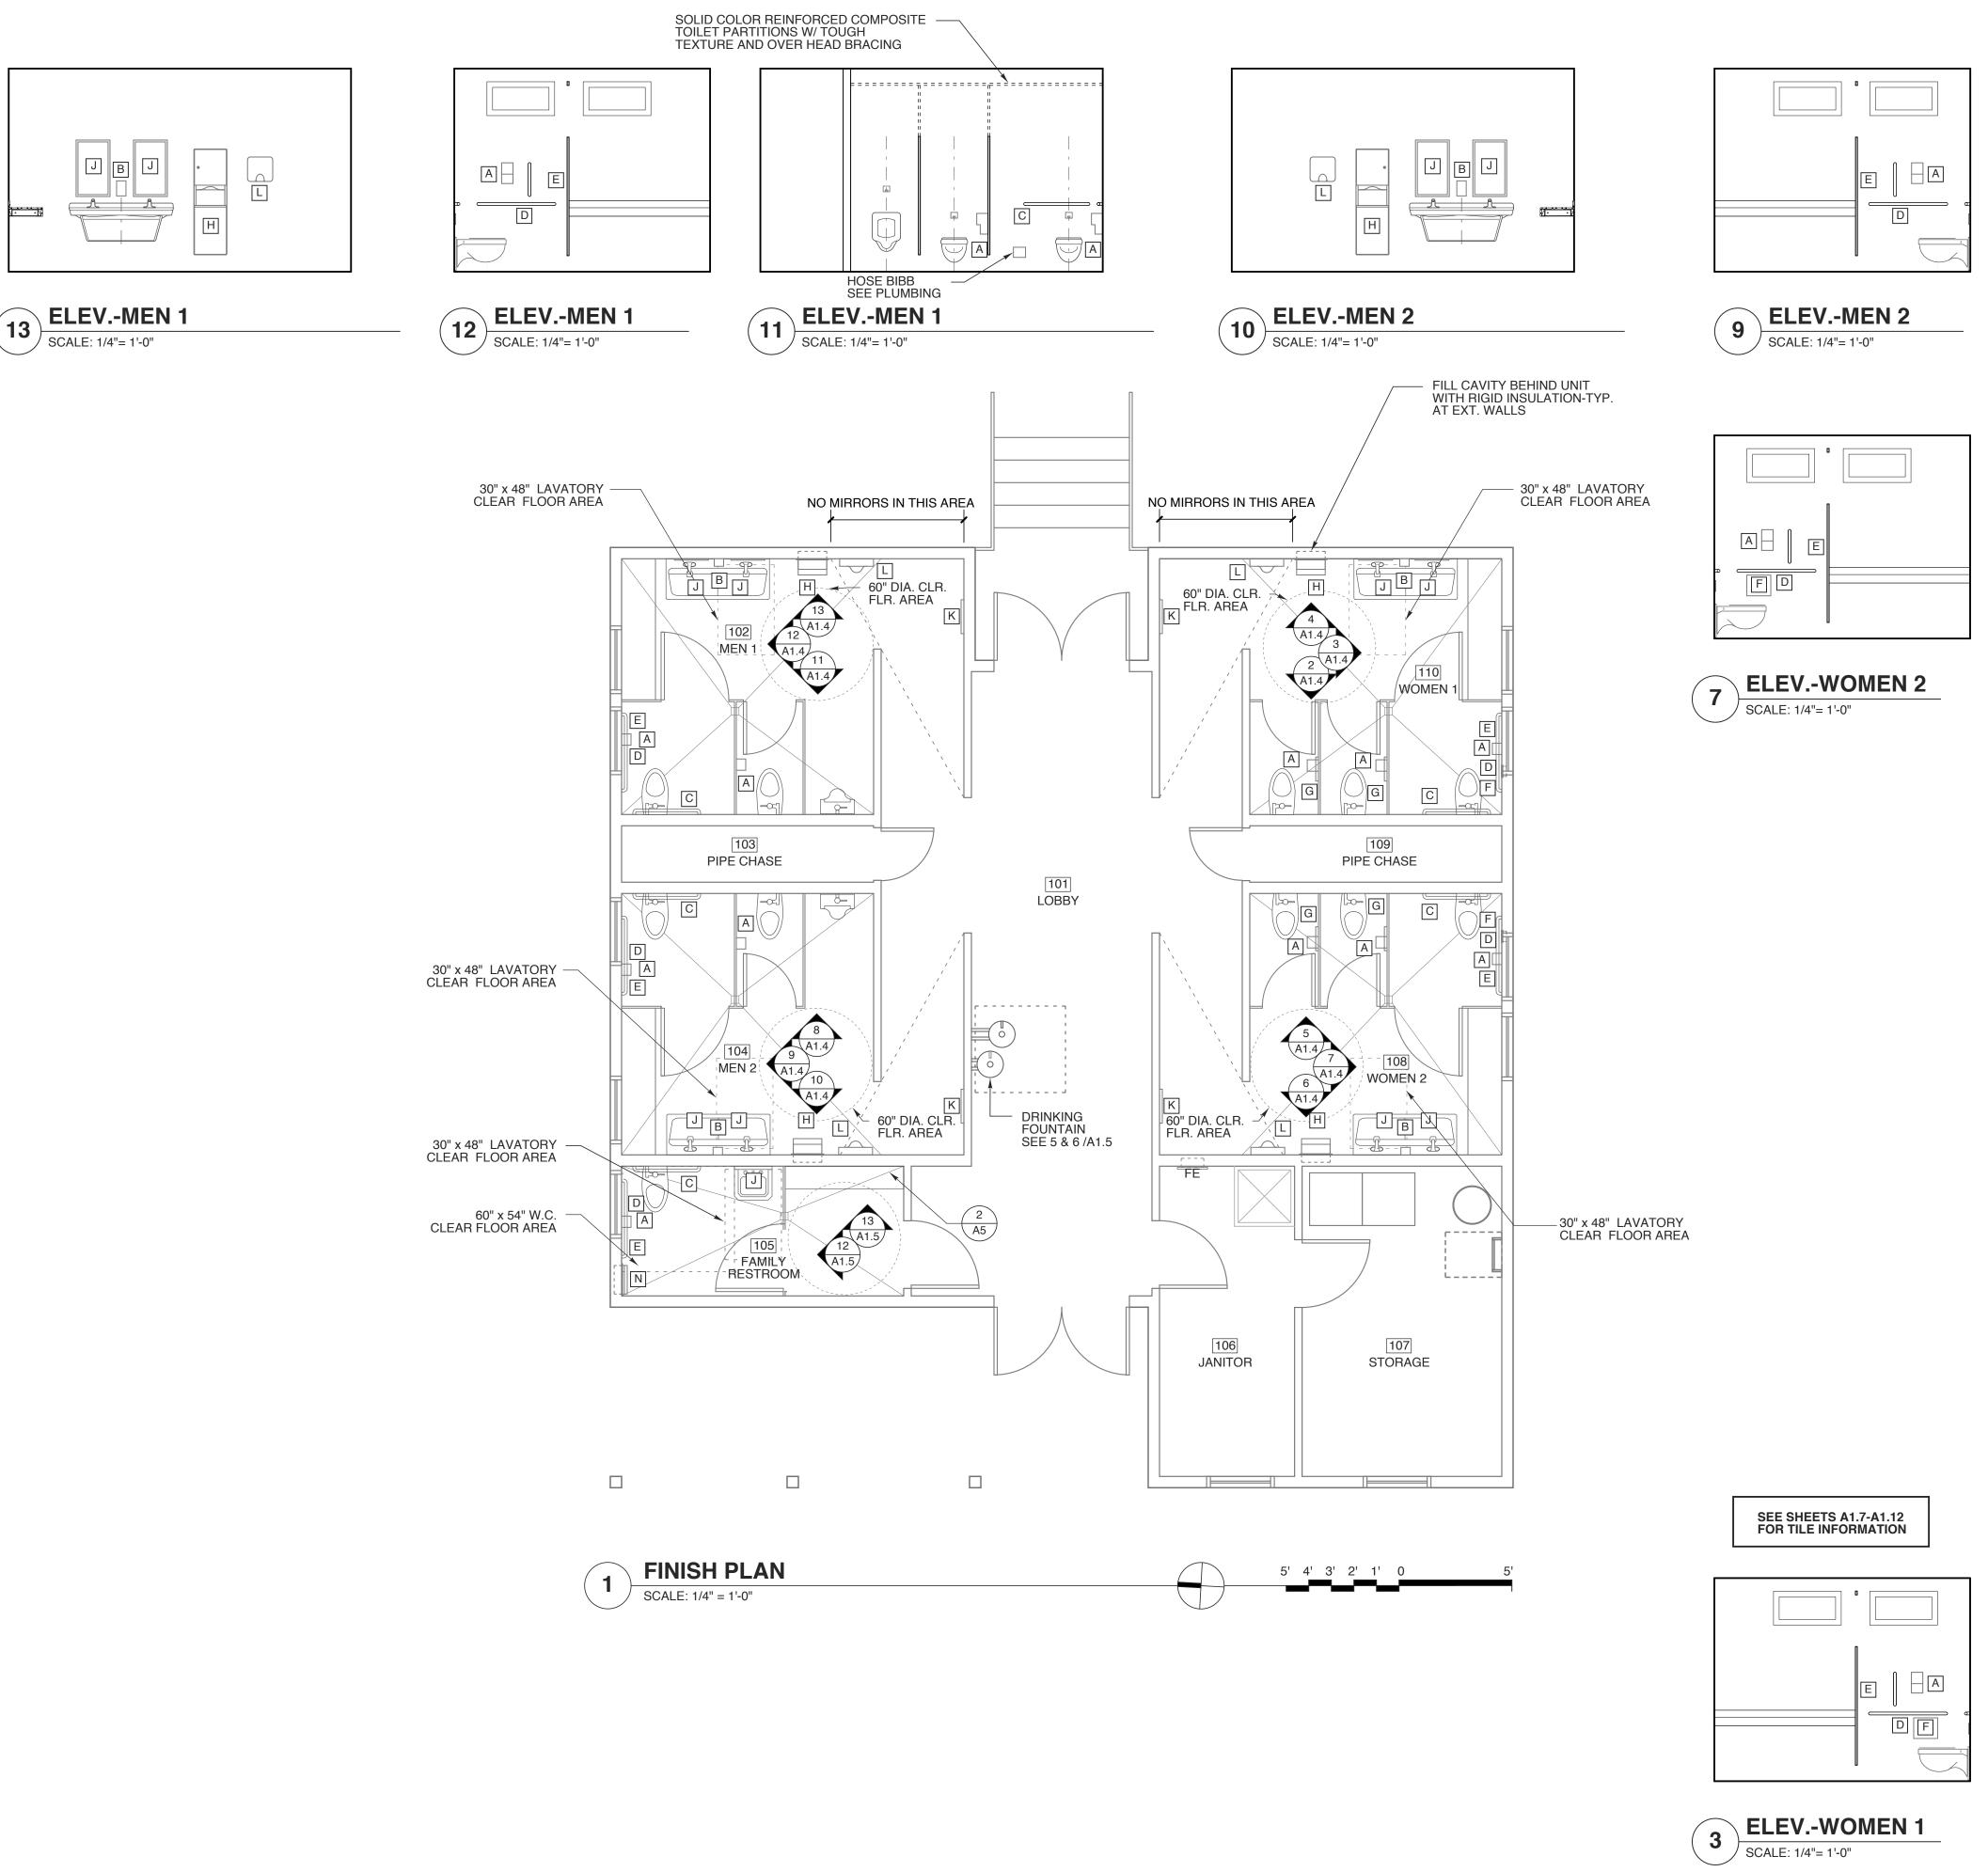


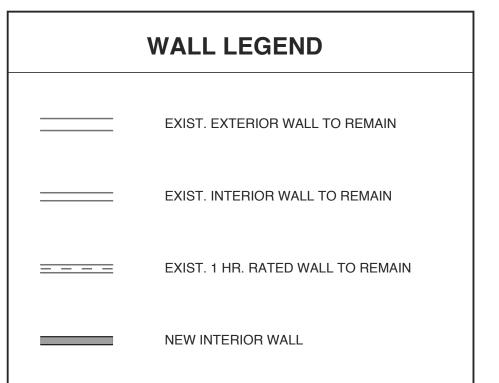
SEMI-RECESSED CABINET NOT LOCKABLE -GLASS DOOR WITH STAINLESS STEEL TRIM; HANDLE 48" MARSHALL

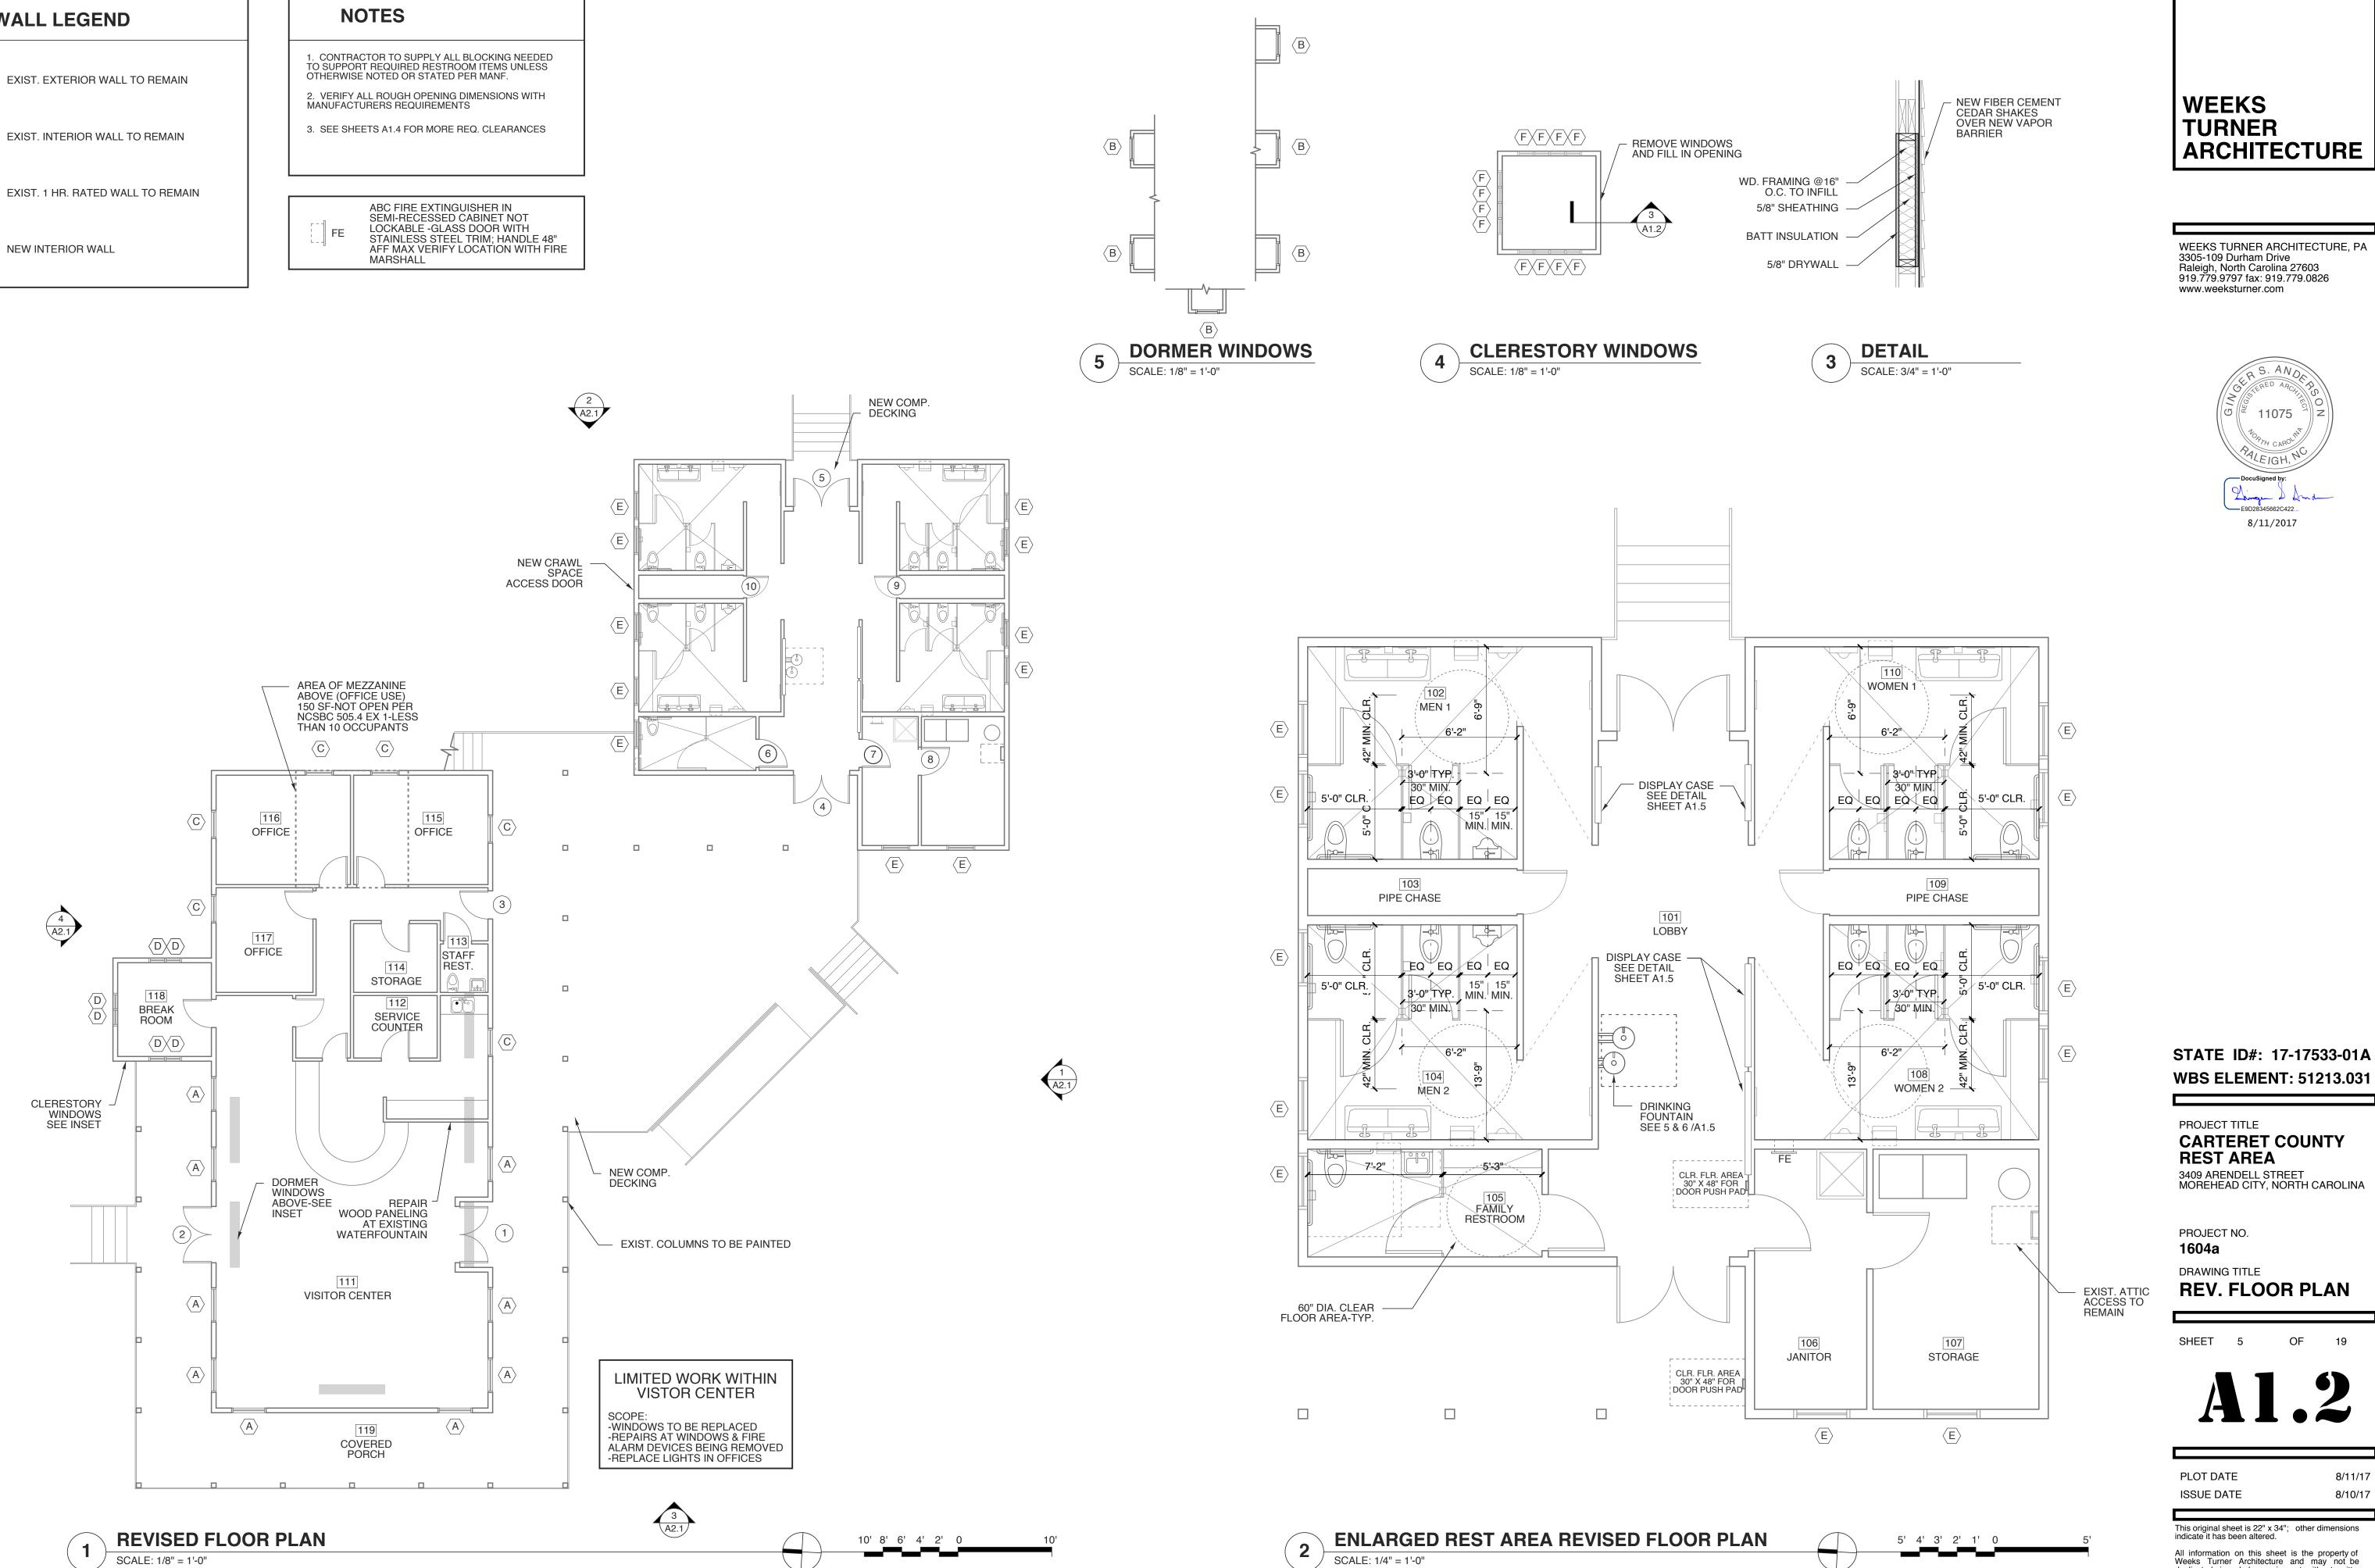

duplicated in whole or in part without written authorization from Weeks Turner Architecture. 2017 $\textcircled{\mbox{\sc c}}$




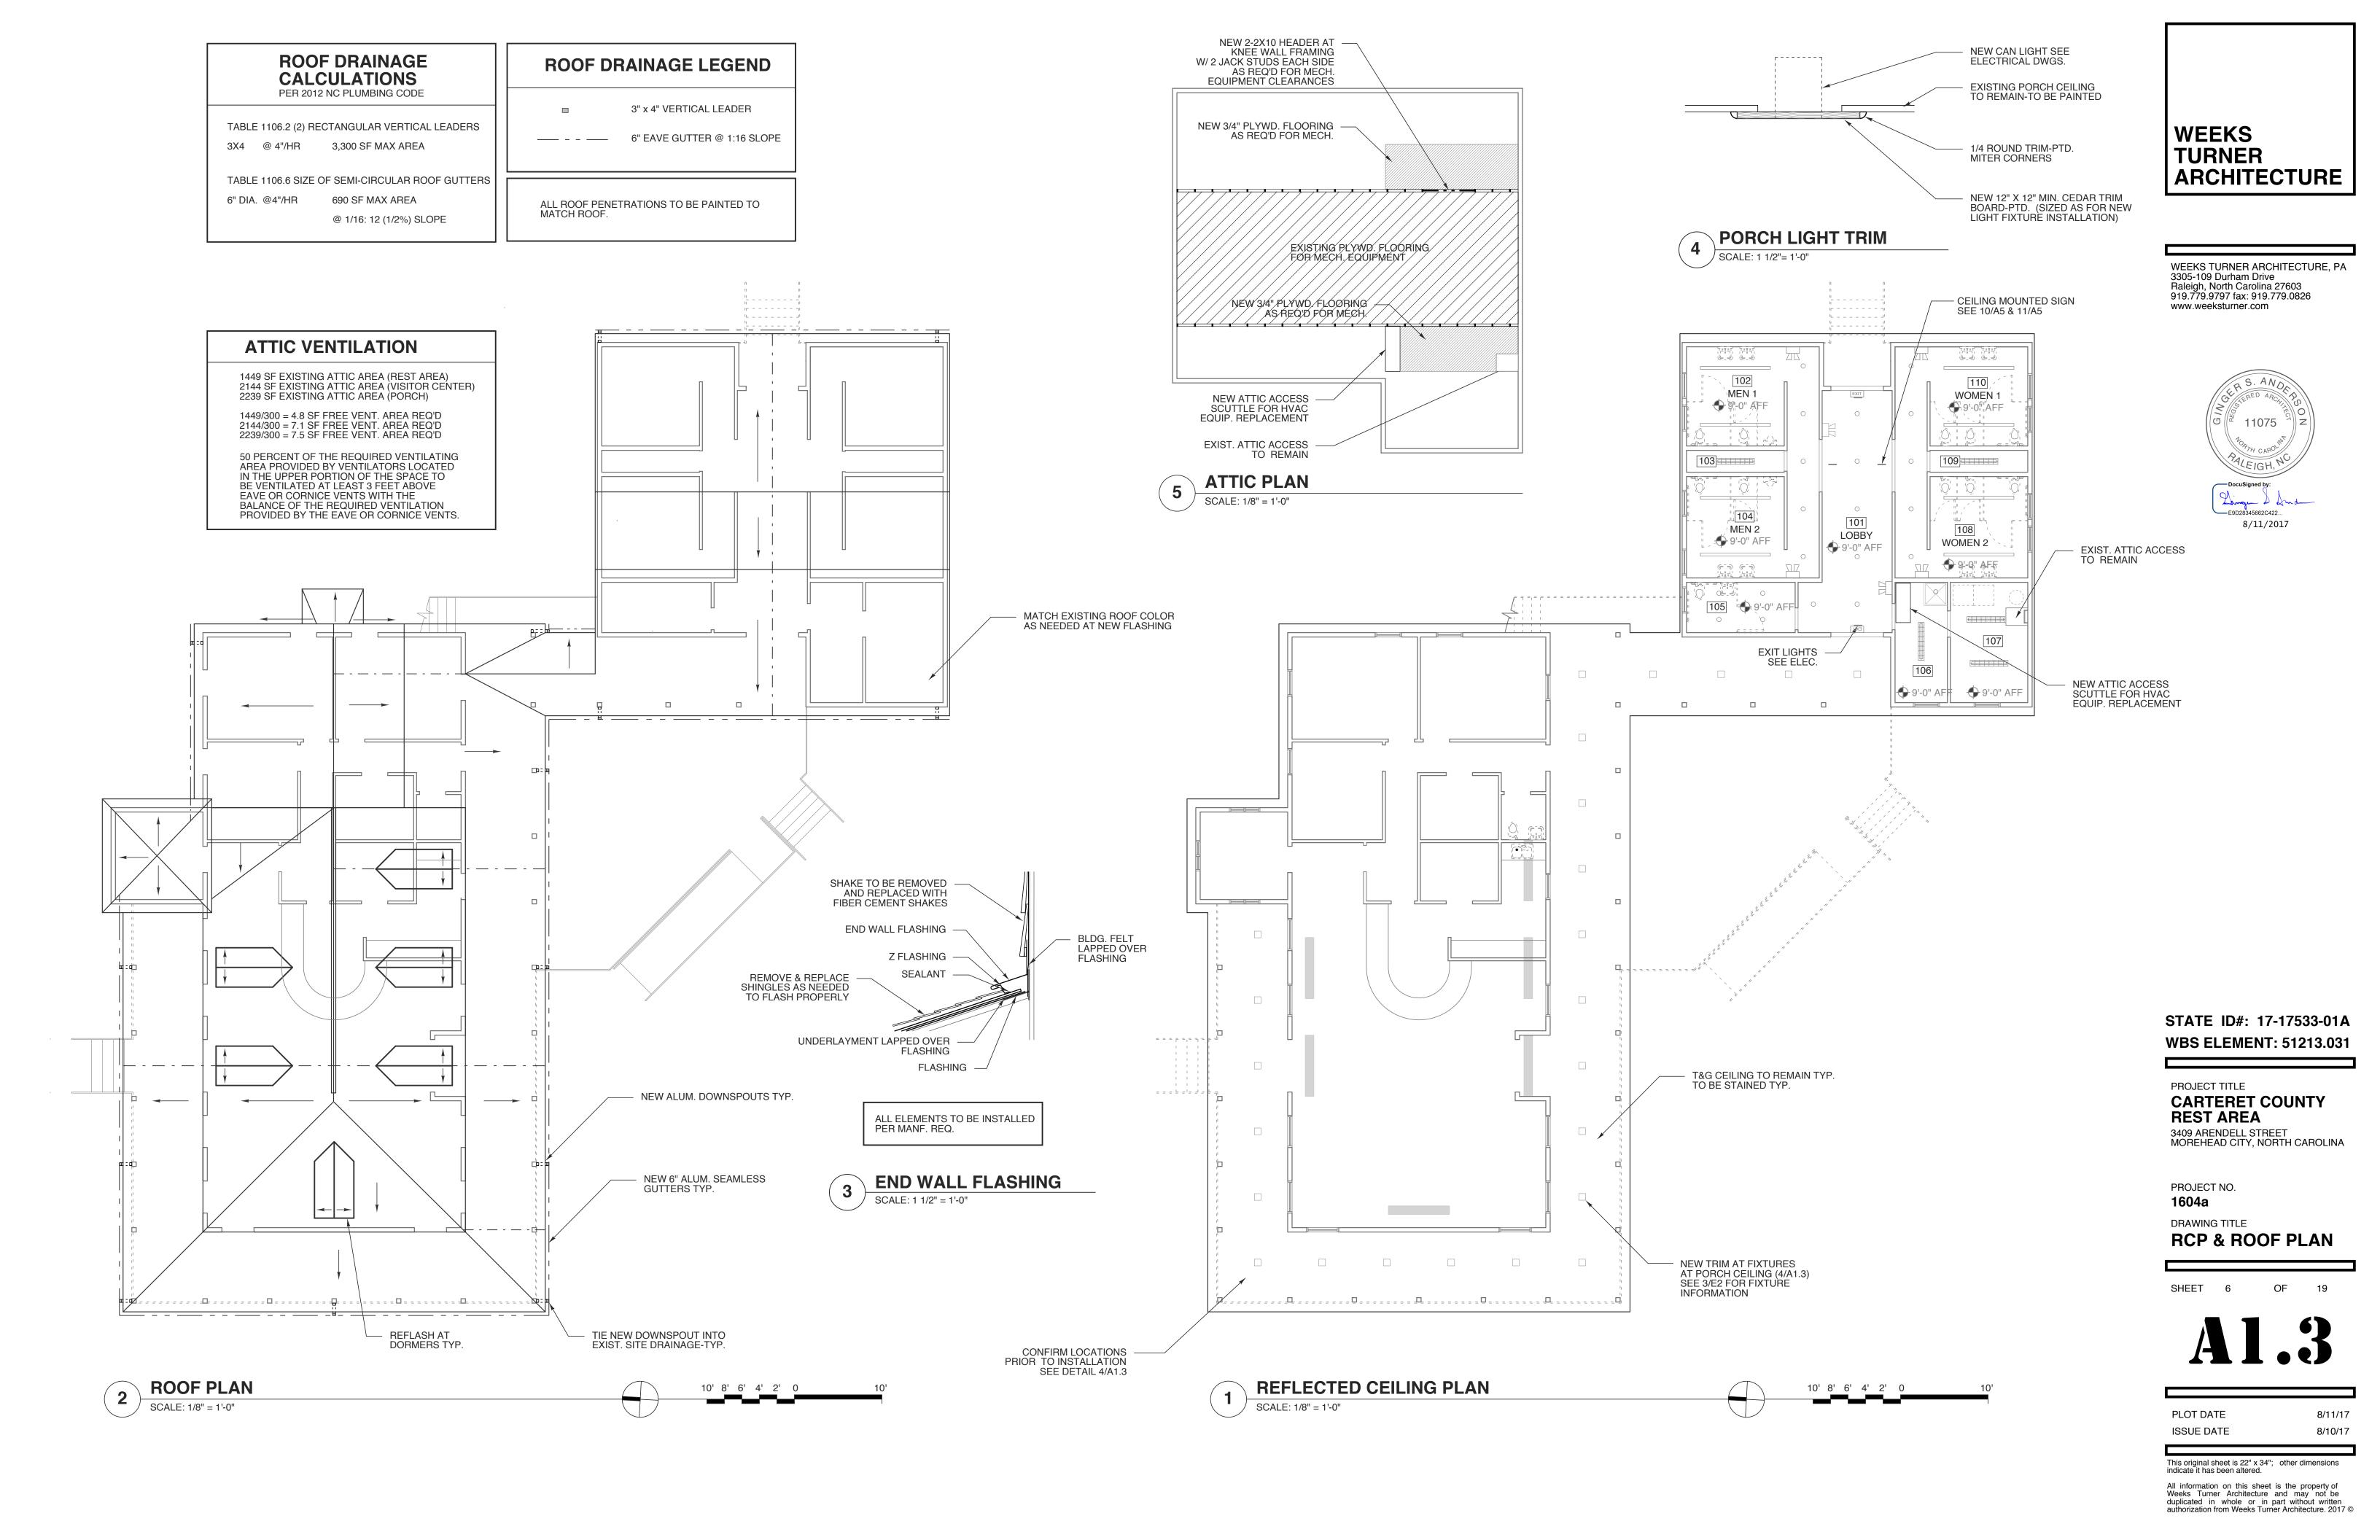

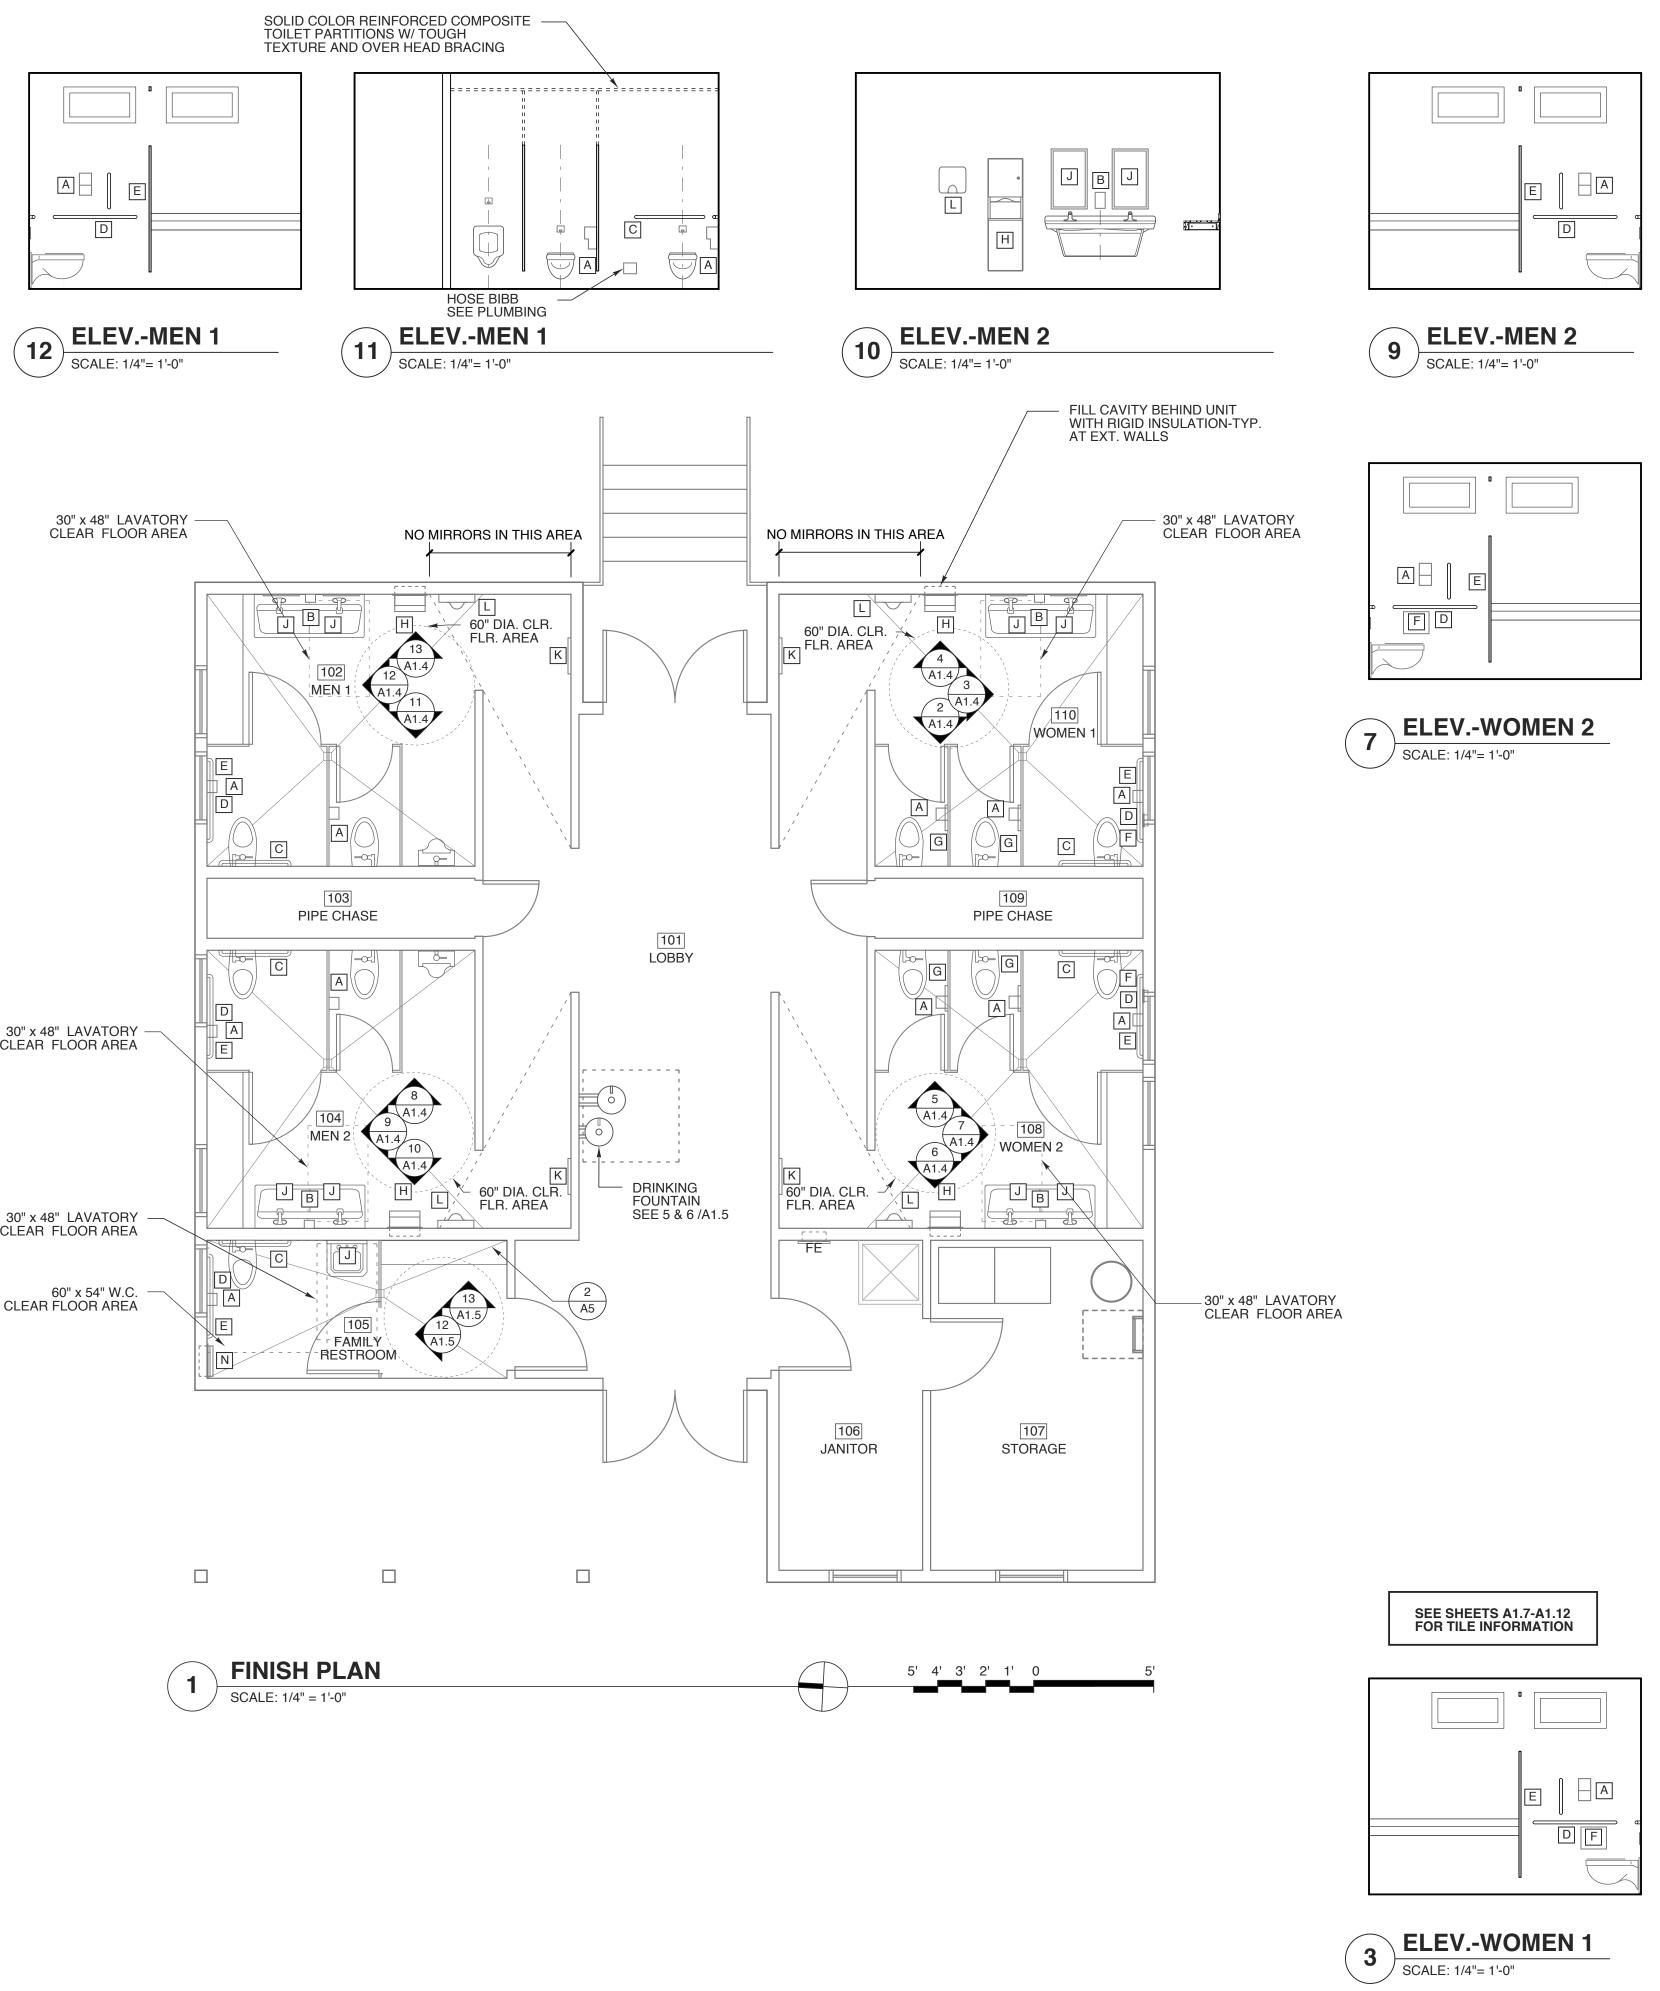





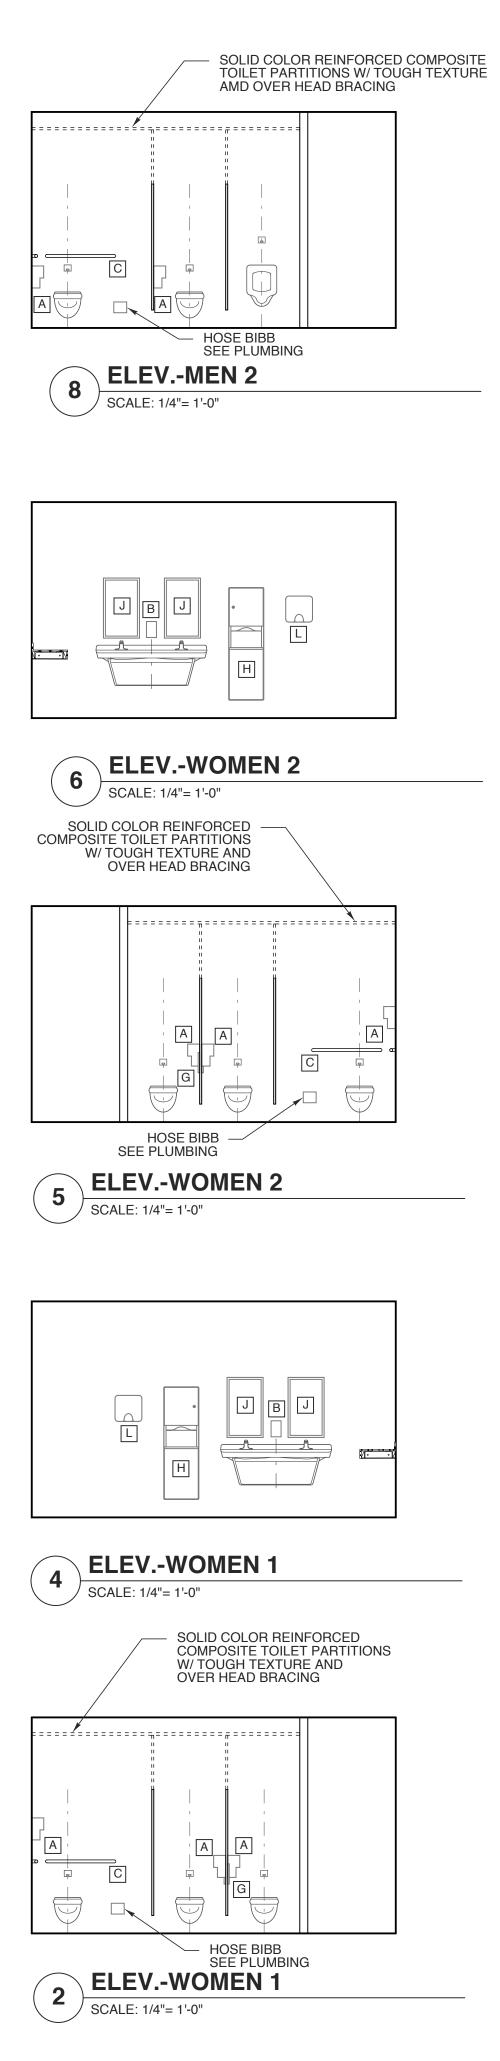

WEEKS TURNER ARCHITECTURE


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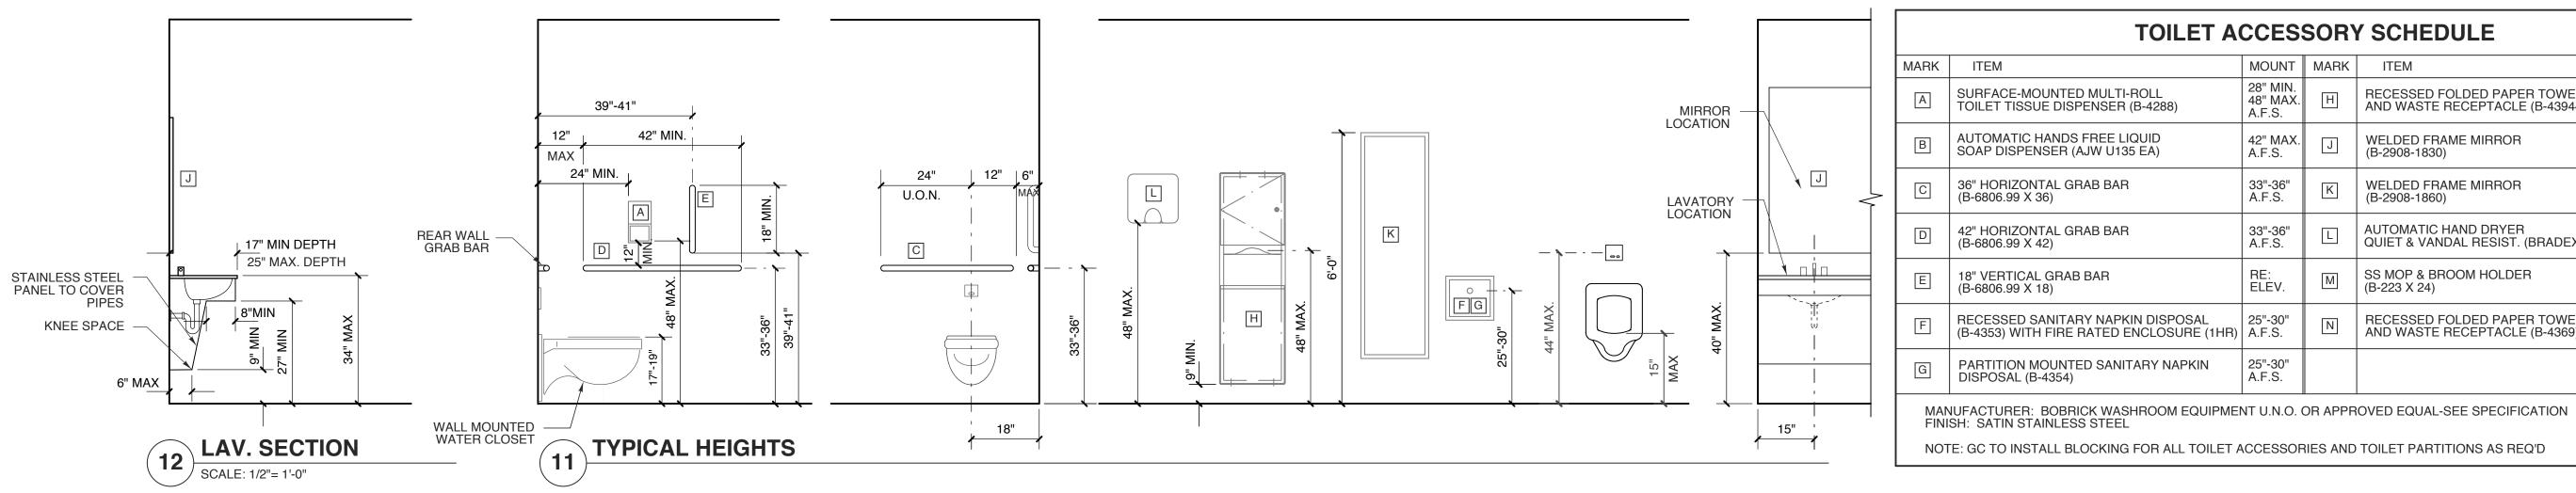
STATE ID#: 17-17533-01A WBS ELEMENT: 51213.031


PROJECT TITLE **CARTERET COUNTY REST AREA** 3409 ARENDELL STREET MOREHEAD CITY, NORTH CAROLINA


PROJECT NO. 1604a DRAWING TITLE **FINISH PLAN**





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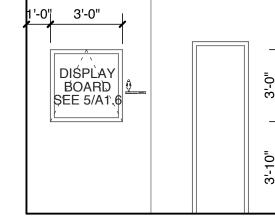


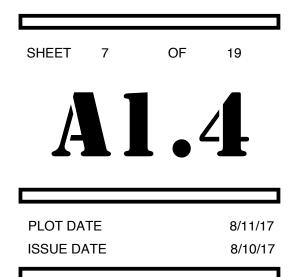

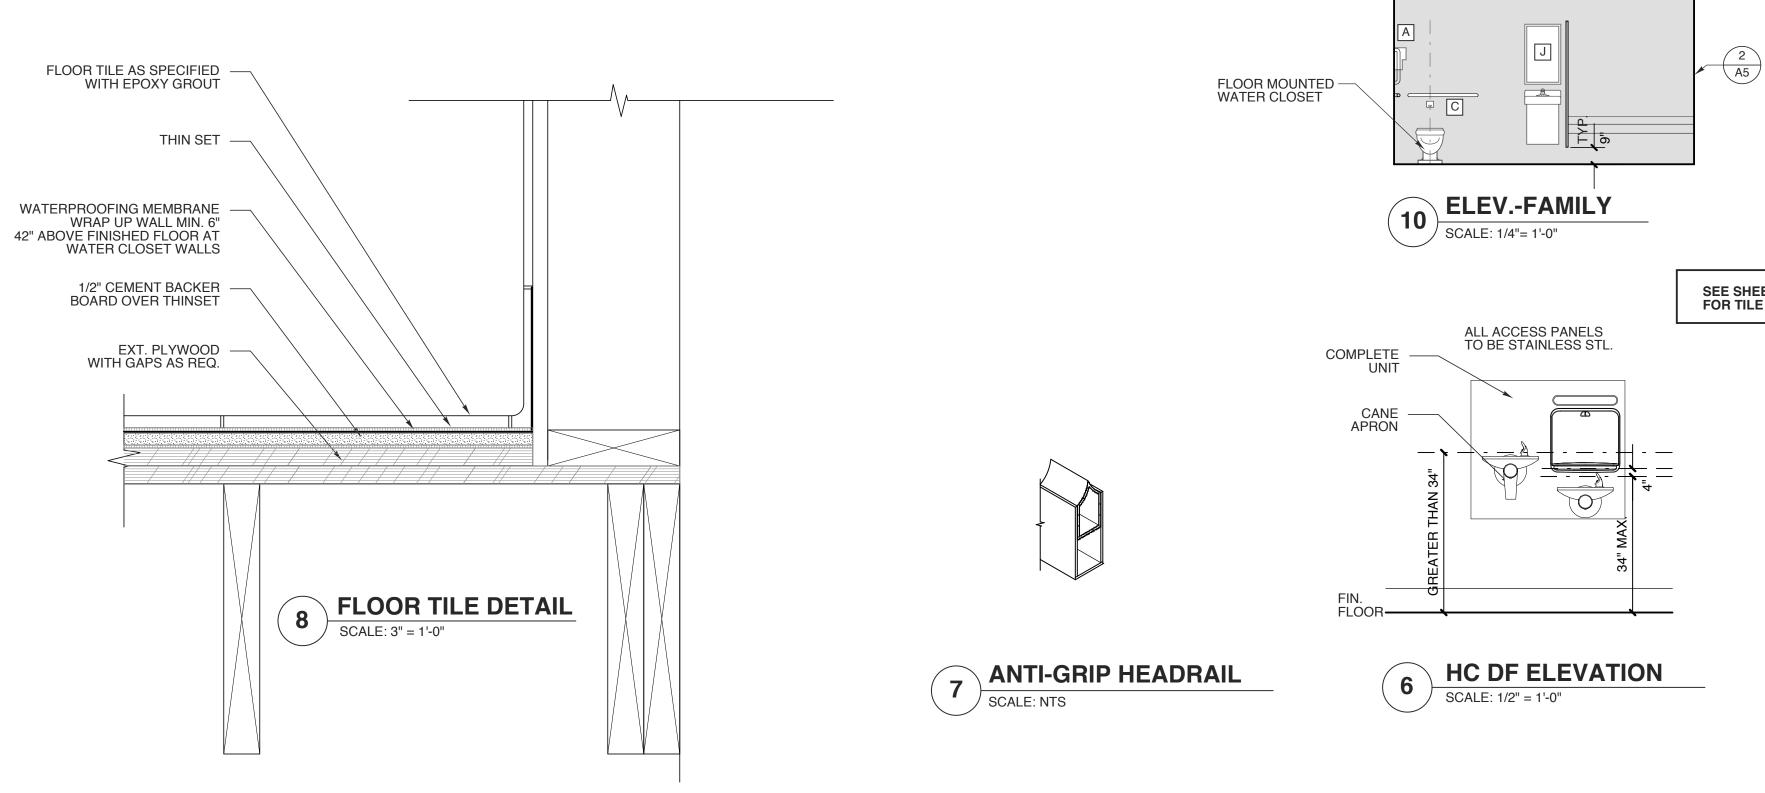ELEV.-LOBBY

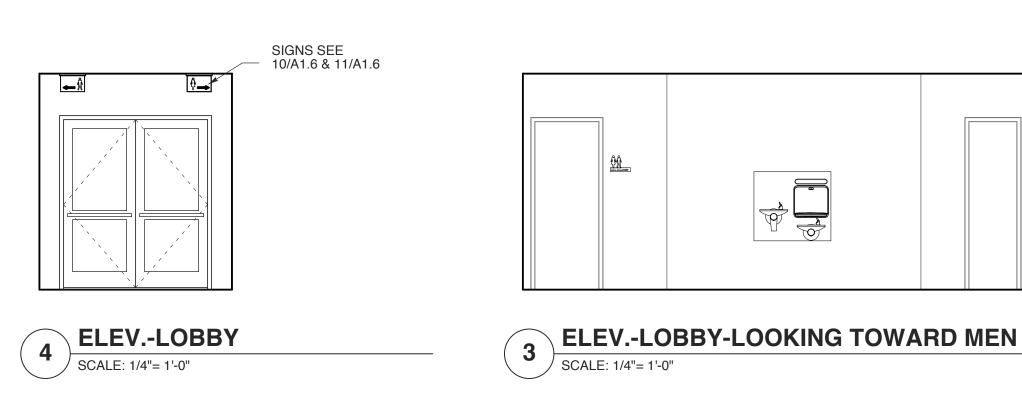) SCALE: 1/4"= 1'-0"

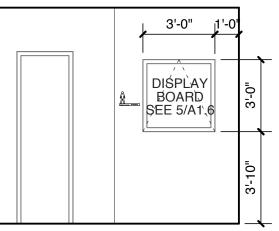2

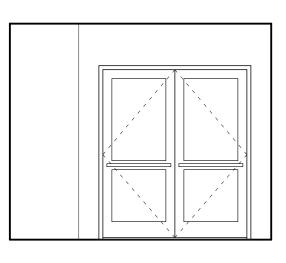


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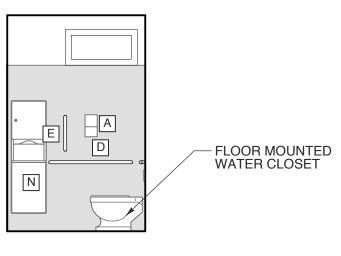


A (ACCESSORY SCHEDULE						
	MOUNT	MARK	ITEM	MOUNT			
	28" MIN. 48" MAX. A.F.S.	Н	RECESSED FOLDED PAPER TOWEL DISP. AND WASTE RECEPTACLE (B-43944)	RE: ELEV.			
	42" MAX. A.F.S.	J	WELDED FRAME MIRROR (B-2908-1830)	RE: ELEV.			
	33"-36" A.F.S.	К	WELDED FRAME MIRROR (B-2908-1860)	RE: ELEV.			
	33"-36" A.F.S.	L	AUTOMATIC HAND DRYER QUIET & VANDAL RESIST. (BRADEX 2902-28)	48" A.F.S.			
	RE: ELEV.	Μ	SS MOP & BROOM HOLDER (B-223 X 24)	60"-72" A.F.S.			
R)	25"-30" A.F.S.	Ν	RECESSED FOLDED PAPER TOWEL DISP. AND WASTE RECEPTACLE (B-4369)	RE: ELEV.			
	25"-30" A.F.S.						
ЛЕI	IENT U.N.O. OR APPROVED EQUAL-SEE SPECIFICATION						

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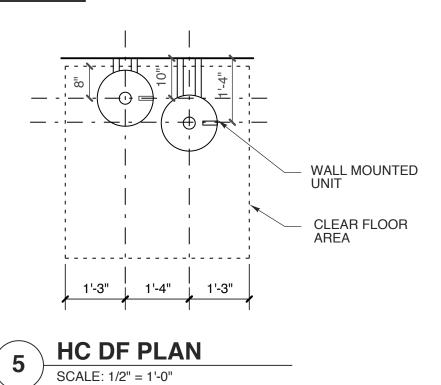
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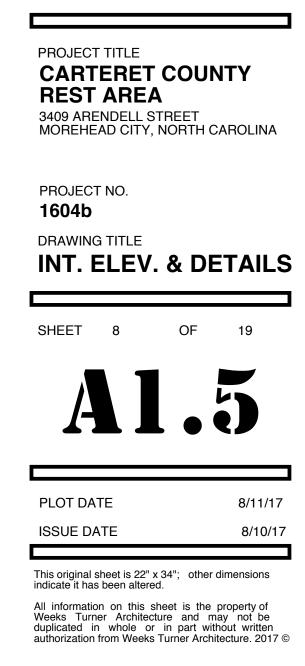






SEE SHEETS A1.7-A1.12 FOR TILE INFORMATION 9" 5'-6" 5'-6" PUSH PAD DISPLAY BOARD SEE 5/A1.6 DISPLAY BOARD SEE 5/A1.6

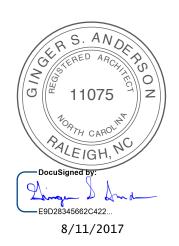ELEV.-LOBBY-LOOKING TOWARD WOMEN

STATE ID#: 17-17533-01A WBS ELEMENT: 51213.031



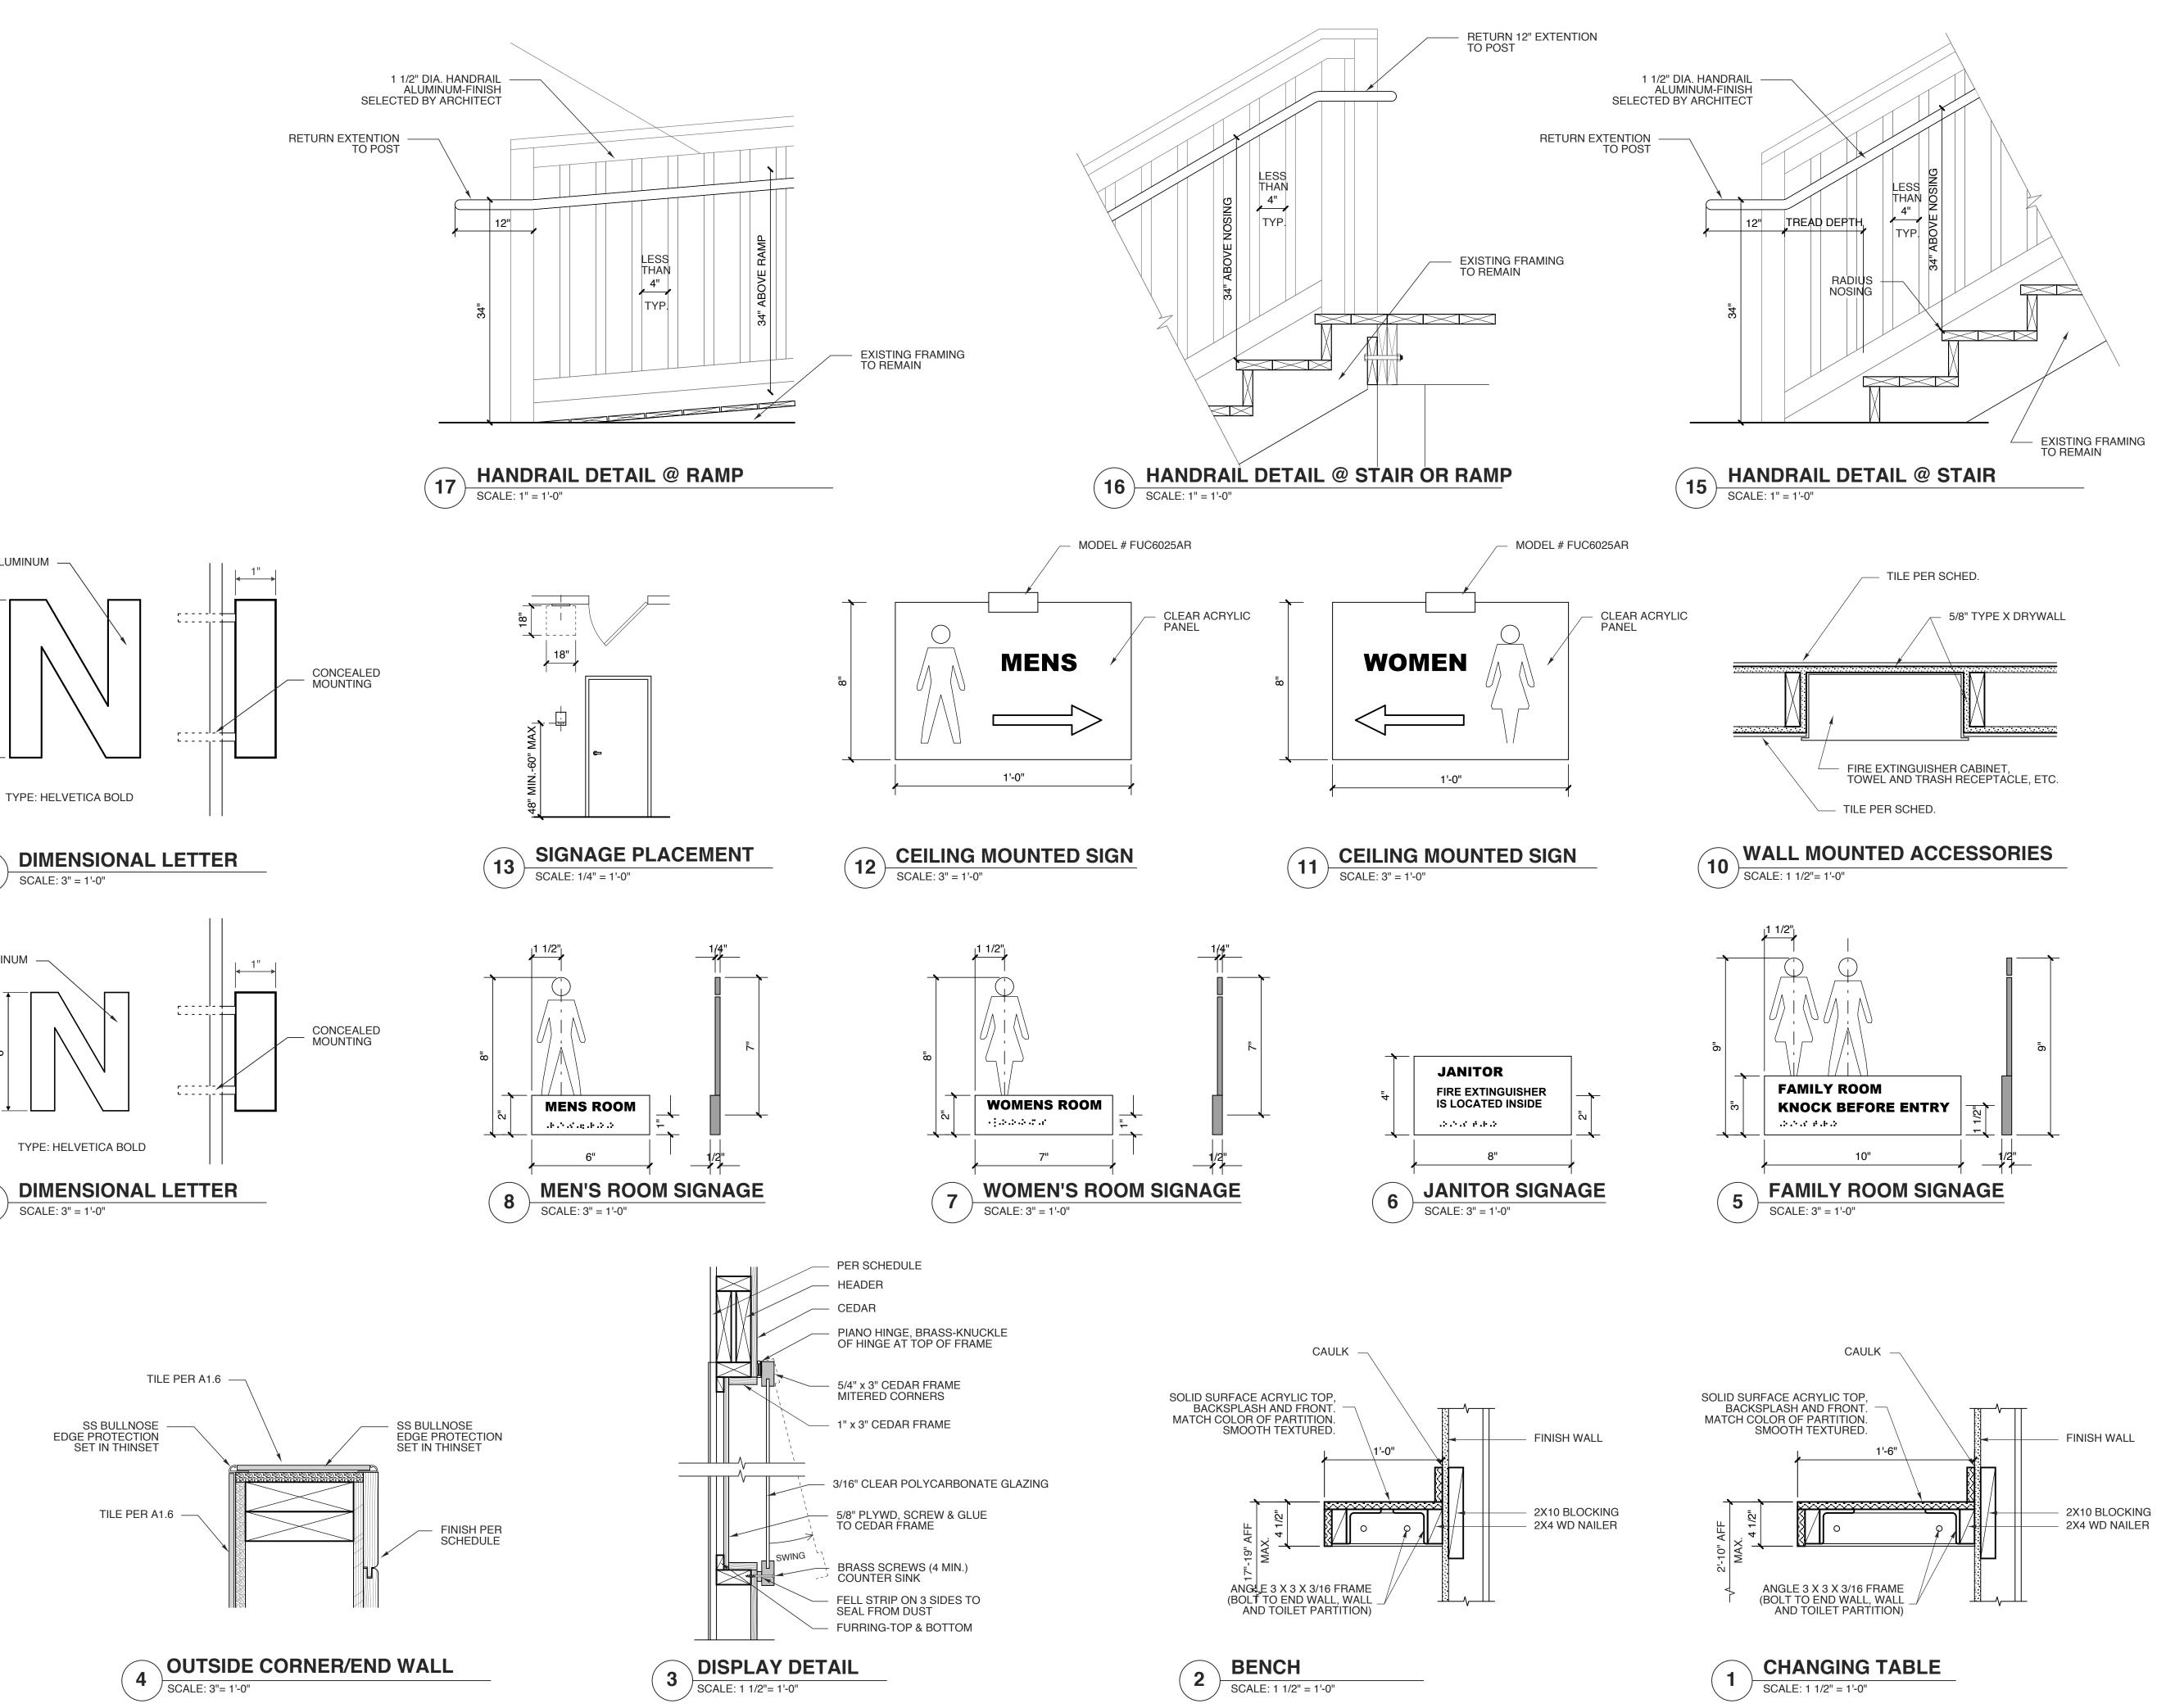

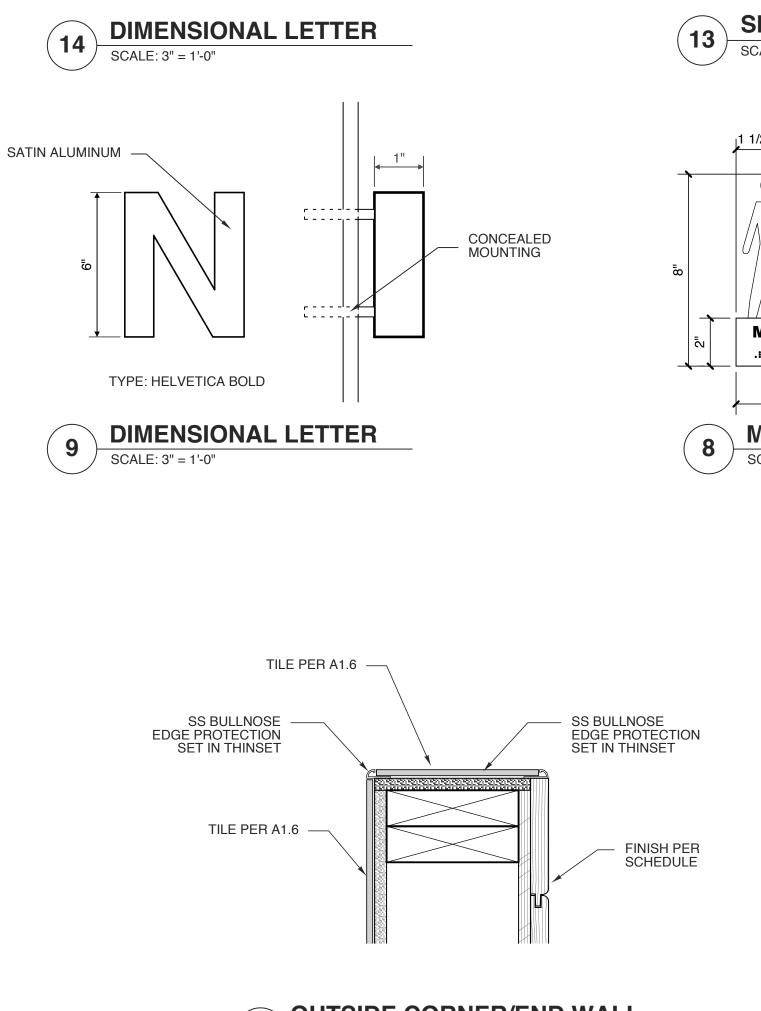

SATIN ALUMINUM

14

9

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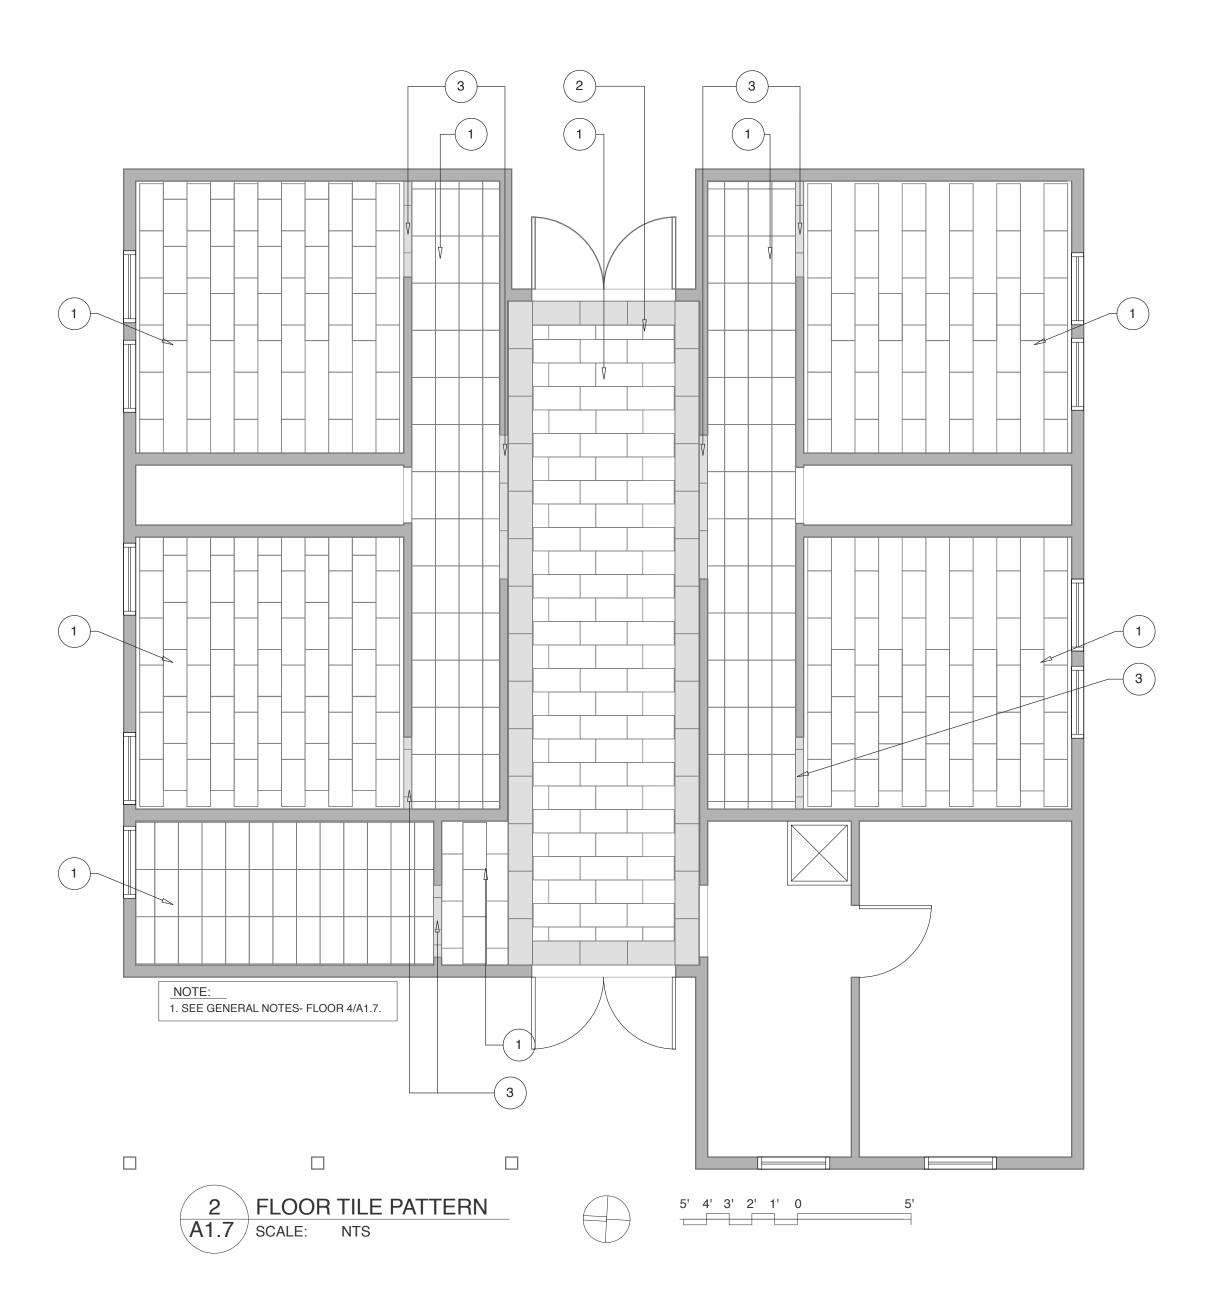
PROJECT TITLE **CARTERET COUNTY REST AREA** 3409 ARENDELL STREET MOREHEAD CITY, NORTH CAROLINA

PROJECT NO. 1604a DRAWING TITLE DETAILS

SHEET 12 OF 13

ISSUE DATE	8/10/17

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LEGEND- TILE	:	
LOCATION	MANUFACTURER	PRODUCT LINE/NAME
FIELD:	DALTILE	RIVER MARBLE, 12"X 24" SANDY FLATS RM91- UNPOLISHED
BORDER:	DALTILE	PLAZA NOVA, 12"X 24" BROWN VISION PN96
ACCENT:	DALTILE	PLAZA NOVA, 4"X 24" BROWN VISION PN96
$\overline{}$		

5	LEGE	ND- TILE	
A1.7	SCALE:	1/4" = 1'-0"	

FLC	OR TILE INDENTIFICATION NUMBER		
	FIELD TILE		
2	BORDER		
3	ACCENT		
7 LEGEND- TILE			
A1.7	SCALE: 1/4" = 1'-0"		

LEGEND- GROUT:				
LOCATION	MANUFACTURER	PRODUCT LINE/NAME		
FIELD:	CUSTOM BUILDING PRODUCTS	# 92 ADMIRAL BLUE		
BORDER:	CUSTOM BUILDING PRODUCTS	# 92 ADMIRAL BLUE		
ACCENT:	CUSTOM BUILDING PRODUCTS	# 92 ADMIRAL BLUE		

LEGEND- GROUT 6

A1.7 SCALE: 1/4" = 1'-0"


GENERAL NOTES- WALL:


- 1. THE GC SHALL BE RESPONSIBLE FOR FIELD VERIFICATION ALL DIMENSIONS.
- 2. FOR TILE, SEE LEGENDS 1- 13/A1.9.
- 3. FOR GROUT, SEE LEGEND 15/A1.9.
- 4. FOR PAINT AND STAIN, SEE LEGEND 16/A1.9.
- 5. FOR OUTSIDE CORNER WALL, SEE LEGEND 14/A1.9.
- 7. FOR LAVATORY/ WATER WALLS (MEN 1, MEN 2, WOMEN 1, WOMEN 2) FIELD TILE SHALL BE RUN HORIZONTALLY (STACKED) AND IS 3/8" THICKNESS ADJOINING ACCENT
- 8. FOR WATER WALLS (MEN 1, MEN 2, WOMEN 1, WOMEN 2), CUT ACCENT TILE 60" WIDE INTO 24" WIDE AND CENTER ON EACH FIXTURE. 9. FOR FIELD WALL (FAMILY ROOM), FIELD TILE SHALL BE RUN VERTICALY (STACKED) AND CENTER ON EACH FIXTURE .
- 10. FOR LARGE SIZE TILE (20" AND LARGER), SEE MANUFACTURER RECOMMENDATION.
- 11. FOR RECTANGULAR INSTALLATION, SEE MANUFACTURER RECOMMENDATION.
- 12. FOR GROUT JOINT, SEE MANUFACTURER RECOMMENDATION.
- 13. ALIGN VERTICAL TILE JOINTS IN LOBBY.
- 14. ALIGN HORIZONTAL TILE JOINTS IN FAMILY.
- 15. FOR ALTERNATE PIPE CHASE WALL (WOMEN & MEN), SEE ART WORK WALL ALTERNATE- 1 ELEV. 1/A1.11. SEE GENERAL NOTES- WALL NOTE 18.
- 16. FOR ALTERNATE DISPLAY CASE- 2 WALL, SEE ART WORK WALL ALTERNATE- 2 ELEV. 1/A1.12. SEE GENERAL NOTES- WALL NOTE 18.
- 17. FOR ALTERNATE WATER FOUNTAIN WALL, SEE ART WORK WALL ALTERNATE- 3 ELEV. 4/A1.12. SEE GENERAL NOTES- WALL NOTE 18.
- 18. ALL ART WALLS TO BE WATER JET CUT AND INSTALLED BY A COMPANY WITH EXPERIENCE IN THIS CUTTING METHOD. MOCK-UPS TO BE PROVIDED AND APPROVED BY DESIGNER PRIOR TO WORK. ANY SUBSTITUTION TO BE SUBMITTED FOR APPROVAL 10 DAYS PRIOR TO BIDDING.



GENERAL NOTES- FLOOR:

- 1. THE GC SHALL BE RESPONSIBLE FOR FIELD VERIFICATION ALL DIMENSIONS.
- 2. FOR TILE, SEE LEGEND 5/A1.7.
- 3. FOR GROUT, SEE LEGEND 6/A1.7. 4. FOR IDENTIFICATION NUMBER, SEE 7/A1.7.
- 5. FOR STAGGERED INSTALLATION, SEE MANUFACTURE RECOMMENDATION.
- 6. FOR GROUT JOINT, SEE MANUFACTURER RECOMMENDATION.
- 7. TILE INSTALLER TO DISTRIBUTE TILE EVENLY ACROSS THE TILED AREA AVOIDING SMALL TILE.

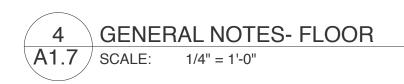

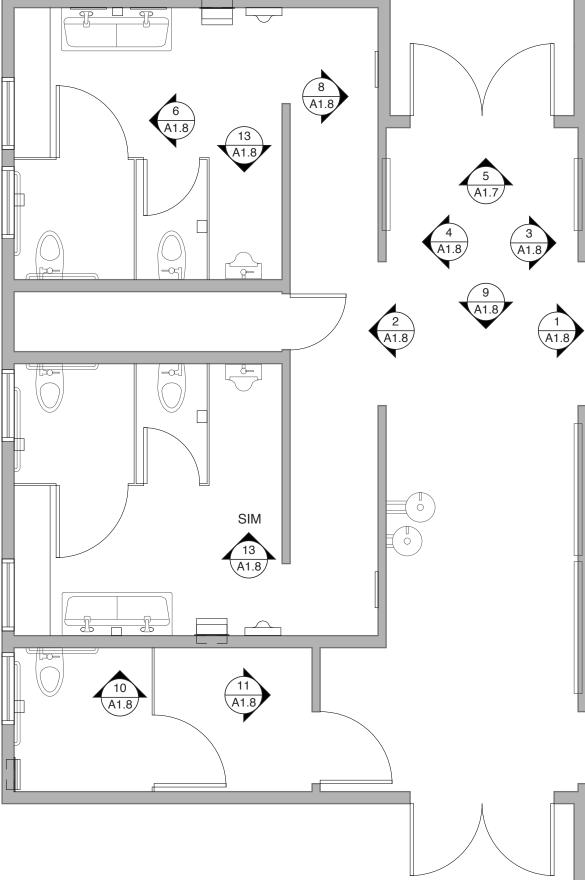



6. FOR LAVATORY/ WATER (WATERCLOST/ URINAL)/ WATER FOUNTAIN WALLS, CENTER TILE ON FIXTURE. COORDINATE WITH GC AND PLUMBER THE CENTER OF THE FIXTURE. TILE AND SHALL BE RUN VERTICALLY AND IS 1/4" THICKNESS. CONTRACTOR IS REQUIRED TO INSTALL THE ACCENT TILE TO A FLUSH LEVEL WITH FIELD TILE.

 $\overline{}$ A1.8 A1.8 5' 4' 3' 2' 1' 0

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STATE ID#: 17-17533-01A WBS ELEMENT: 51213.031

PROJECT TITLE **CARTERET COUNTY REST AREA** 3409 ARENDELL STREET MOREHEAD CITY, NORTH CAROLINA

PROJECT NO. 1604a DRAWING TITLE **TILE LAYOUT**

SHEET	10	OF	19
A			7
PLOT DAT ISSUE DA			8/11/17 8/10/17

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A1.8 / SCALE: 1/4" = 1'-0"





LEGEND- TILE:		
LOCATION	MANUFACTURER	PRODUCT LINE/NAME
PIPE CHASE WALL- WOMEN:		
COVE BASE:	DALTILE	PLAZA NOVA: 6"X 12" BROWN VISION PN96
FIELD TILE- 1:	DALTILE	JEWEL TIDE: 5/8" SUNSET PATH JT08- RANDOM MOSAIC (MESH-MOUNTED ON A 12"X 12" SHEET)
FIELD TILE- 2:	DALTILE	JEWEL TIDE: 5/8" SPARKLING SAND JT01- RANDOM MOSAIC (MESH-MOUNTED ON A 12"X 12" SHEET)
ACCENT- 1:	AMERICAN OLEAN	UNGLAZED CERAMIC MOSAICS: 1" ANTIQUE ROSE A11- ROUNDED CORNER BRICKWORK
ACCENT- 2:	AMERICAN OLEAN	UNGLAZED CERAMIC MOSAICS: 1" ANTIQUE ROSE SPECKLED A11- ROUNDED CORNER BRICKWORK
ACCENT- 3:	AMERICAN OLEAN	UNGLAZED CERAMIC MOSAICS: 1" ICE WHITE A25- ROUNDED CORNER BRICKWORK

LEGEND- PIPE CHASE WALL- WOMEN 1

A1.9 SCALE: 1/4" = 1'-0"

LOCATION		PRODUCT LINE/NAME
LOCATION	MANOLACTOREN	
DISPLAY CASE-2 WALL:		
COVE BASE:	DALTILE	PLAZA NOVA: 6"X 12" BROWN VISION PN96
WAVE WALL FIELD TILE:	DALTILE	MODERN DIMENSIONS: 4-1/4"X 12-3/4" WATERFALL
ACCENT:	DALTILE	UPTOWN GLASS: (PEARL METRO & EXOTIC): 1"X 1" PEARL BLUE UP15- MESH-MOUNTED ON A 12"X 12" SHEET
DISPLAY CASE- 1 WALL:		
COVE BASE:	DALTILE	PLAZA NOVA: 6"X 12" BROWN VISION PN96
FIELD TILE:	DALTILE	GLASS HORIZONS: 2-1/2"X 7-3/4" SKY BLUE GH03



LEGEND- TILE:		
LOCATION	MANUFACTURER	PRODUCT LINE/NAME
FIELD WALL:		
COVE BASE:	DALTILE	PLAZA NOVA: 6"X 12" BROWN VISION PN96
FIELD TILE:	DALTILE	FORMULA: 24"X 48" THEOREM IVORY FM93- POLISHED
FAMILY ROOM ACCENT WALL:		
COVE BASE:	DALTILE	PLAZA NOVA: 6"X 12" BROWN VISION PN96
ACCENT TILE:	DALTILE	COLORWAVE: 3"X 6" ICE WHITE CW01



6 LEGEND- FAMILY/ MEN- WINDOW WALL

A1.9 SCALE: 1/4" = 1'-0"

LEGEND- TILE:		
LOCATION	MANUFACTURER	PRODUCT LINE/NAME
FRONT WALL:		
COVE BASE:	DALTILE	PLAZA NOVA: 6"X 12" BROWN VISION PN96
FIELD TILE:	DALTILE	GLASS HORIZONS: 2-1/2"X 7-3/4" SKY BLUE GH03
FAMILY ROOM ACCENT WALL:		
COVE BASE:	DALTILE	PLAZA NOVA: 6"X 12" BROWN VISION PN96
ACCENT TILE:	DALTILE	COLORWAVE: 3"X 6" ICE WHITE CW01



I EGEND- TILE.

LEGEND HEE.		
LOCATION	MANUFACTURER	PRODUCT LINE/NAME
FIELD WALL: COVE BASE:	DALTILE	PLAZA NOVA: 6"X 12" BROWN VISION PN96
FIELD TILE:	DALTILE	FORMULA: 24"X 48" THEOREM IVORY FM93- POLISHED

12 LEGEND WOMEN WALL A1.9 SCALE: 1/4" = 1'-0"

LEGEND- GROUT:			
LOCATION	MANUFACTURER	PRODUCT LINE/NAME	
WALL:	CUSTOM BUILDING PRODUCTS	# 10 ANTIQUE WHITE	
COVE BASE:	CUSTOM BUILDING PRODUCTS	# 92 ADMIRAL BLUE	
COVE BASE CORNER:	CUSTOM BUILDING PRODUCTS	# 92 ADMIRAL BLUE	

15	LEGEN	D- GROUT
A1.9	SCALE:	1/4" = 1'-0"

LEGEND- TILE:		
LOCATION	MANUFACTURER	PRODUCT LINE/NAME
PIPE CHASE WALL-MEN:		
COVE BASE:	DALTILE	PLAZA NOVA: 6"X 12" BROWN VISION PN96
	DALTILE	FLAZA NOVA. 6 X 12 BROWN VISION FIN96
FIELD TILE- 1:	DALTILE	JEWEL TIDE: 5/8" SUNSET PATH JT08- RANDOM MOSAIC (MESH-MOUNTED ON A 12"X 12" SHEET)
FIELD TILE- 2:	DALTILE	JEWEL TIDE: 5/8" SPARKLING SAND JT01- RANDOM MOSAIC (MESH-MOUNTED ON A 12"X 12" SHEET)
ACCENT- 1:	AMERICAN OLEAN	UNGLAZED CERAMIC MOSAICS: 1" PEACOCK BLUE A08- ROUNDED CORNER BRICKWORK
ACCENT- 2:	AMERICAN OLEAN	UNGLAZED CERAMIC MOSAICS: 1" BIMINI BLUE SPECKLED A85- ROUNDED CORNER BRICKWORK
ACCENT- 3:	AMERICAN OLEAN	UNGLAZED CERAMIC MOSAICS: 1" ICE WHITE A25- ROUNDED CORNER BRICKWORK
		·

LEGEND- PIPE CHASE WALL- MEN 2 LEGEN A1.9 SCALE:

1/4" = 1'-0"

LEGEND- TILE:				
LOCATION	MANUFACTURER	PRODUCT LINE/NAME		
WATER FOUNTAIN WALL:				
COVE BASE:	DALTILE	PLAZA NOVA: 6"X 12" BROWN VISION PN96		
FIELD TILE:	DALTILE	RIVER MARBLE: 12"X 36" SANDY FLATS RM91- POLISHED		
ACCENT-1:	DALTILE	FASHION ACCENTS: 12"X 12" BROWN PEBBLE F018- DECORATIVE ACCENT		
ACCENT-2:	DALTILE	REFLECTIONS IN GLASS TILE: 1"X 6" BLUE LAGOON- GLOSSY/ MATT FINISH- MESH-MOUNTED		
FAMILY ROOM EXTERIOR WALL:				
COVE BASE:	DALTILE	PLAZA NOVA: 6"X 12" BROWN VISION PN96		
FIELD TILE:	DALTILE	GLASS HORIZONS: 2-1/2"X 7-3/4" SKY BLUE GH03		
DISPLAY CASE-1 WALL:				
COVE BASE:	DALTILE	PLAZA NOVA: 6"X 12" BROWN VISION PN96		
FIELD TILE:	DALTILE	GLASS HORIZONS: 2-1/2"X 7-3/4" SKY BLUE GH03		



4 LEGEND- LOBBY- LOOKING TOWARD MEN

A1.9 SCALE: 1/4" = 1'-0"

LEGEND- TILE:		
LOCATION	MANUFACTURER	PRODUCT LINE/NAME
FIELD WALL:		
COVE BASE:	DALTILE	PLAZA NOVA: 6"X 12" BROWN VISION PN96
FIELD TILE:	DALTILE	FORMULA: 24"X 48" THEOREM IVORY FM93- POLISHED



7LEGEND- WOMEN- WINDOW WALLA1.9SCALE:1/4" = 1'-0"

LEGEND- TILE:				
LOCATION	MANUFACTURER	PRODUCT LINE/NAME		
FAMILY ROOM FIELD WALL:				
COVE BASE:	DALTILE	PLAZA NOVA: 6"X 12" BROWN VISION PN96		
FIELD TILE:	DALTILE	FORMULA: 24"X 48" THEOREM IVORY FM93- POLISHED		
OPPOSITE FRONT WALL:				
COVE BASE:	DALTILE	PLAZA NOVA: 6"X 12" BROWN VISION PN96		
COVE BASE OUTCORNER:	DALTILE	PLAZA NOVA: 1"X 6" BROWN VISION PN96		
FIELD TILE:	DALTILE	GLASS HORIZONS: 2-1/2"X 7-3/4" SKY BLUE GH03		

10 LEGEND- FAMILY WATER WALL/LOBBY WALL A1.9 SCALE: 1/4" = 1'-0"

-				
LEGEND- TILE:				
LOCATION MANUFAC		PRODUCT LINE/NAME		
WATER WALL:				
COVE BASE:	DALTILE	PLAZA NOVA: 6"X 12" BROWN VISION PN96		
FIELD TILE- 1:	STONEPEAK	PLANE: 60"X 120" TRUE WHITE USP12060094- POLISHED		
FIELD WALL: COVE BASE:	DALTILE	PLAZA NOVA: 6"X 12" BROWN VISION PN96		
FIELD TILE:	DALTILE	FORMULA: 24"X 48" THEOREM IVORY FM93- POLISHED		
OUTSIDE CORNER WALL:				
COVE BASE:	DALTILE	PLAZA NOVA: 6"X 12" BROWN VISION PN96		
ACCENT TILE:	STONEPEAK	PLANE: 60"X 120" TRUE WHITE USP12060094- POLISHED		

13 LEGEND- MEN & WOMEN- WATER WALL A1.9 SCALE:

LEGEND- TILE:				
LOCATION	MANUFACTURER	PRODUCT LINE/NAME		
ACCENT WALL: COVE BASE:	DALTILE	PLAZA NOVA: 6"X 12" BROWN VISION PN96		
ACCENT TILE:	STONEPEAK	PLANE: 60"X 120" TRUE WHITE USP12060094- POLISHED		
FIELD WALL: COVE BASE:	DALTILE	PLAZA NOVA: 6"X 12" BROWN VISION PN96		
FIELD TILE:	DALTILE	FORMULA: 24"X 48" THEOREM IVORY FM93- POLISHED		
OUTSIDE CORNER WALL: COVE BASE:	DALTILE	PLAZA NOVA: 6"X 12" BROWN VISION PN96		
ACCENT TILE:	STONEPEAK	PLANE: 60"X 120" TRUE WHITE USP12060094- POLISHED		
REAR WALL: COVE BASE:	DALTILE	PLAZA NOVA: 6"X 12" BROWN VISION PN96		
FIELD TILE:	DALTILE	GLASS HORIZONS: 2-1/2"X 7-3/4" SKY BLUE GH03		



LEGEND- TILE:	
LOCATION	MANUFACTU
FIELD WALL:	
COVE BASE:	DALTILE
FIELD TILE:	DALTILE
8 LEGEND- A1.9 SCALE: 1/	MIRRC 4" = 1'-0"

LEGEND- TILE:
LOCATION
FIELD WALL:
COVE BASE:
FIELD TILE:
FAMILY ROOM ACCENT WALL: COVE BASE: ACCENT TILE:
11 LEGEND- F A1.9 SCALE: 1/4" :

LEGEND- ACCESSORIES:				
LOCATION MANUFACTURER PRODUCT LINE/NAME				
OUTSIDE CORNER WALL: EDGE- PROTECTION PROFILE:	SCHLUTER	RONDEC- STAINLESS STEEL		
COVE BASE OUTER CORNER:	DALTILE	PLAZA NOVA: 1"X 6" BROWN VISION PN96		



LEGEND- PAINT/ STAI
LOCATION
GYPSUM WALL: FAMILY ROOM
CEILING:
FRAME (H.M.): DISPLAY CASE- 2 / FAMILY:
PIPE CHASE WALL:
DOOR (WOOD): DISPLAY CASE- 2 / FAMILY WAL PIPECHASE WALL

16 LEGEND- PAINT/ STAIN A1.9 | SCALE:

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5 LEGEND- LOBBY REAR WALL/ WOMEN & MEN FIXTURE WALL

ANUFACTURER	PRODUCT LINE/NAME
DALTILE	PLAZA NOVA: 6"X 12" BROWN VISION PN96
DALTILE	FORMULA: 24"X 48" THEOREM IVORY FM93- POLISHED

MIRROR WALL-SIMILAR (WOMEN & MEN)


MANUFACTURER	PRODUCT LINE/NAME
DALTILE	PLAZA NOVA: 6"X 12" BROWN VISION PN96
DALTILE	FORMULA: 24"X 48" THEOREM IVORY FM93- POLISHED
DALTILE	PLAZA NOVA: 6"X 12" BROWN VISION PN96
DALTILE	COLORWAVE: 3"X 6" ICE WHITE CW01

FAMILY DOOR WALL/MEN WALL

= 1'-0"

14 LEGEND- OUTSIDE CORNER WALL

N:		
	MANUFACTURER	PRODUCT LINE/NAME
	SHERWIN WILLIAMS	WATERSCAPE SW 6470
	SHERWIN WILLIAMS	WATERSCAPE SW 6470
	SHERWIN WILLIAMS	ROMAN COLUMN SW 7562- GLOSS FINISH
	SHERWIN WILLIAMS	DRESS BLUES SW 9176
S:	MINWAX	WHITE WASH PICKLING
	MINWAX	NAVY BLUE

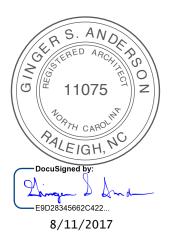


STATE ID#: 17-17533-01A WBS ELEMENT: 51213.031

PROJECT TITLE **CARTERET COUNTY REST AREA**


3409 ARENDELL STREET MOREHEAD CITY, NORTH CAROLINA

PROJECT NO. 1604a DRAWING TITLE TILE LEGENDS

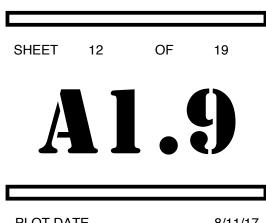


PLOT DATE 8/11/17 **ISSUE DATE** 8/10/17


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A1.10 SCALE: 1 1/2" = 1'-0"

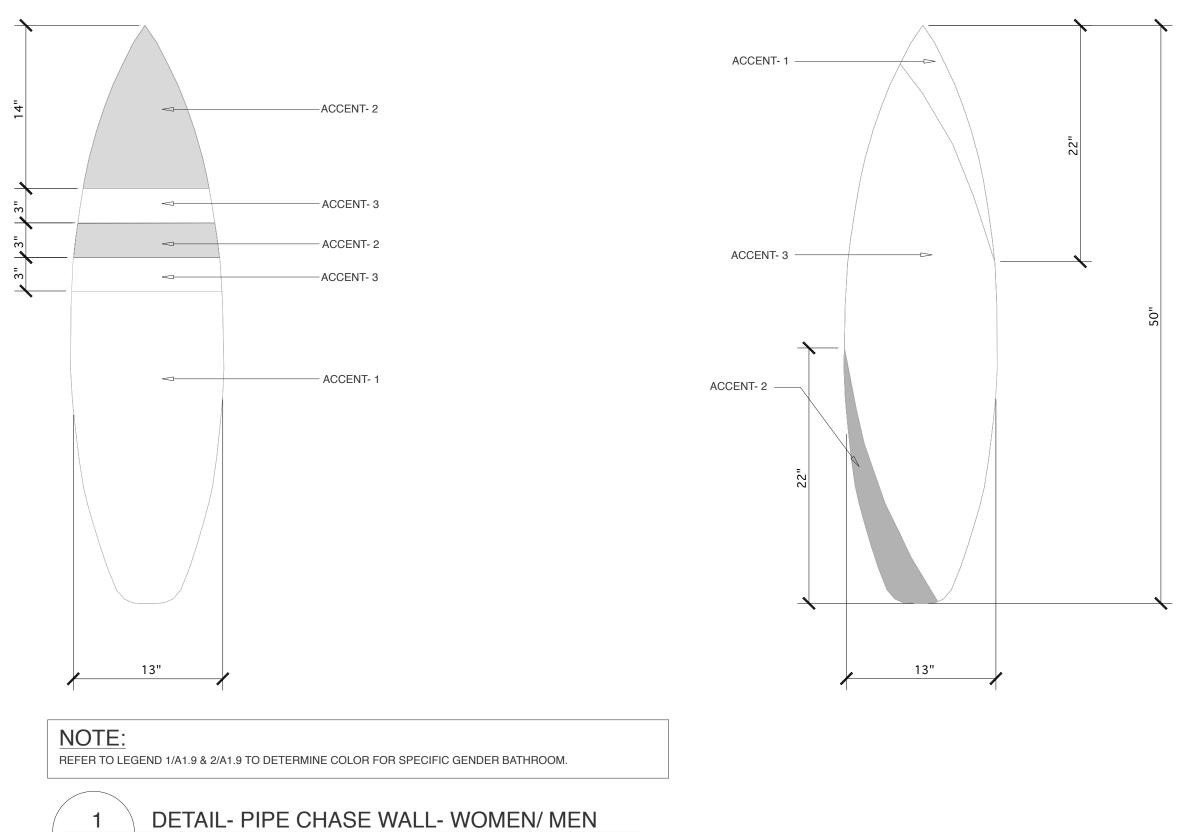



DETAIL- WATER FOUNTAIN WALL

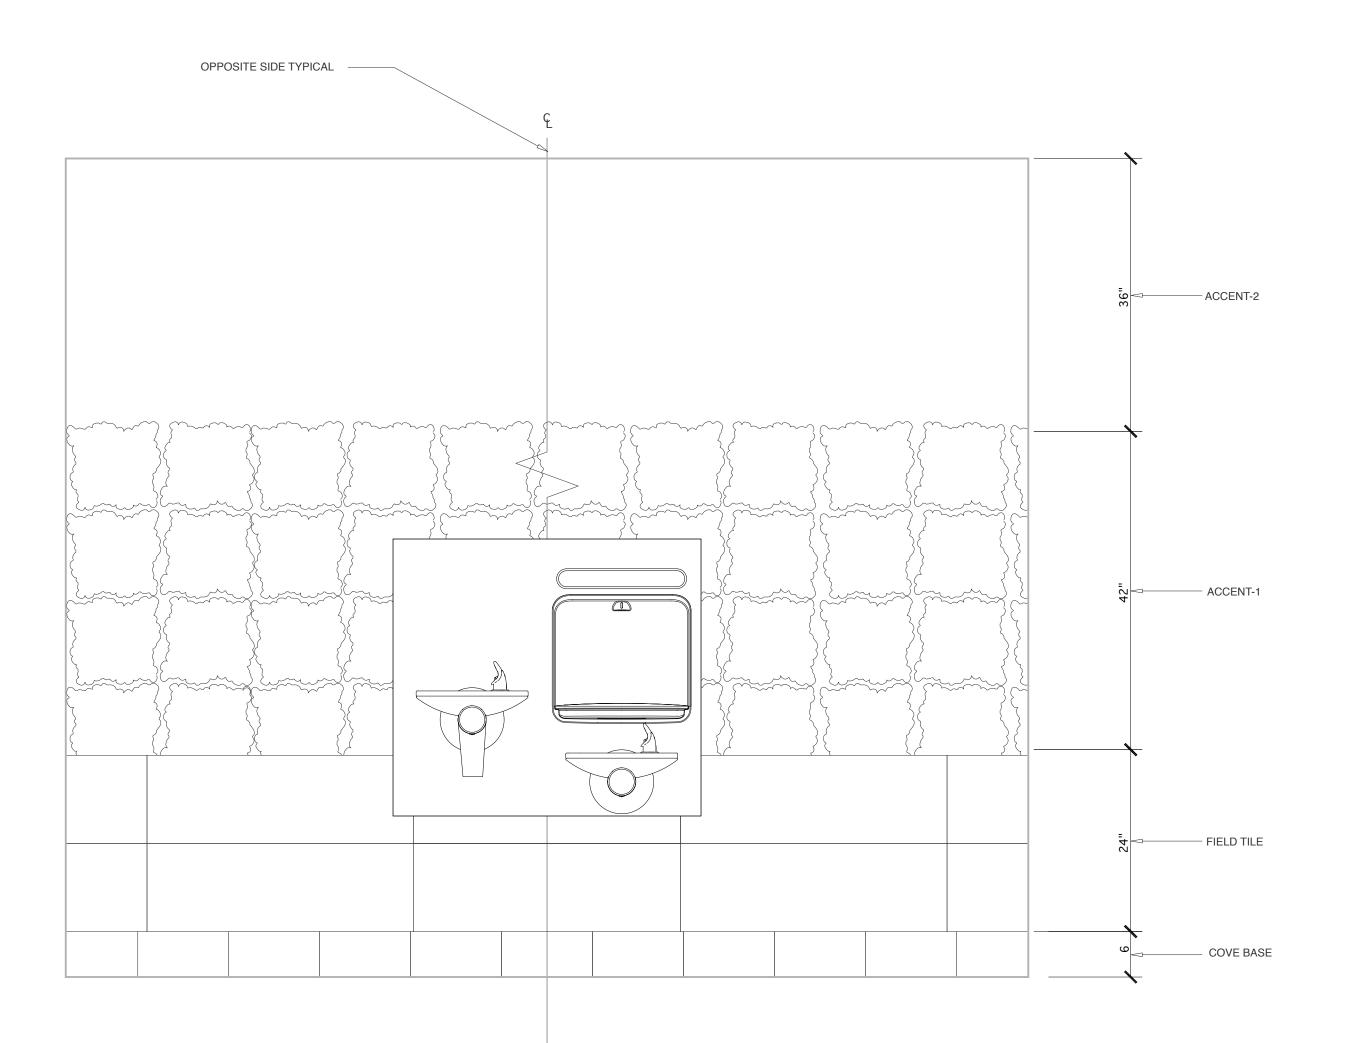A1.10 SCALE: 1" = 1'-0"

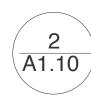

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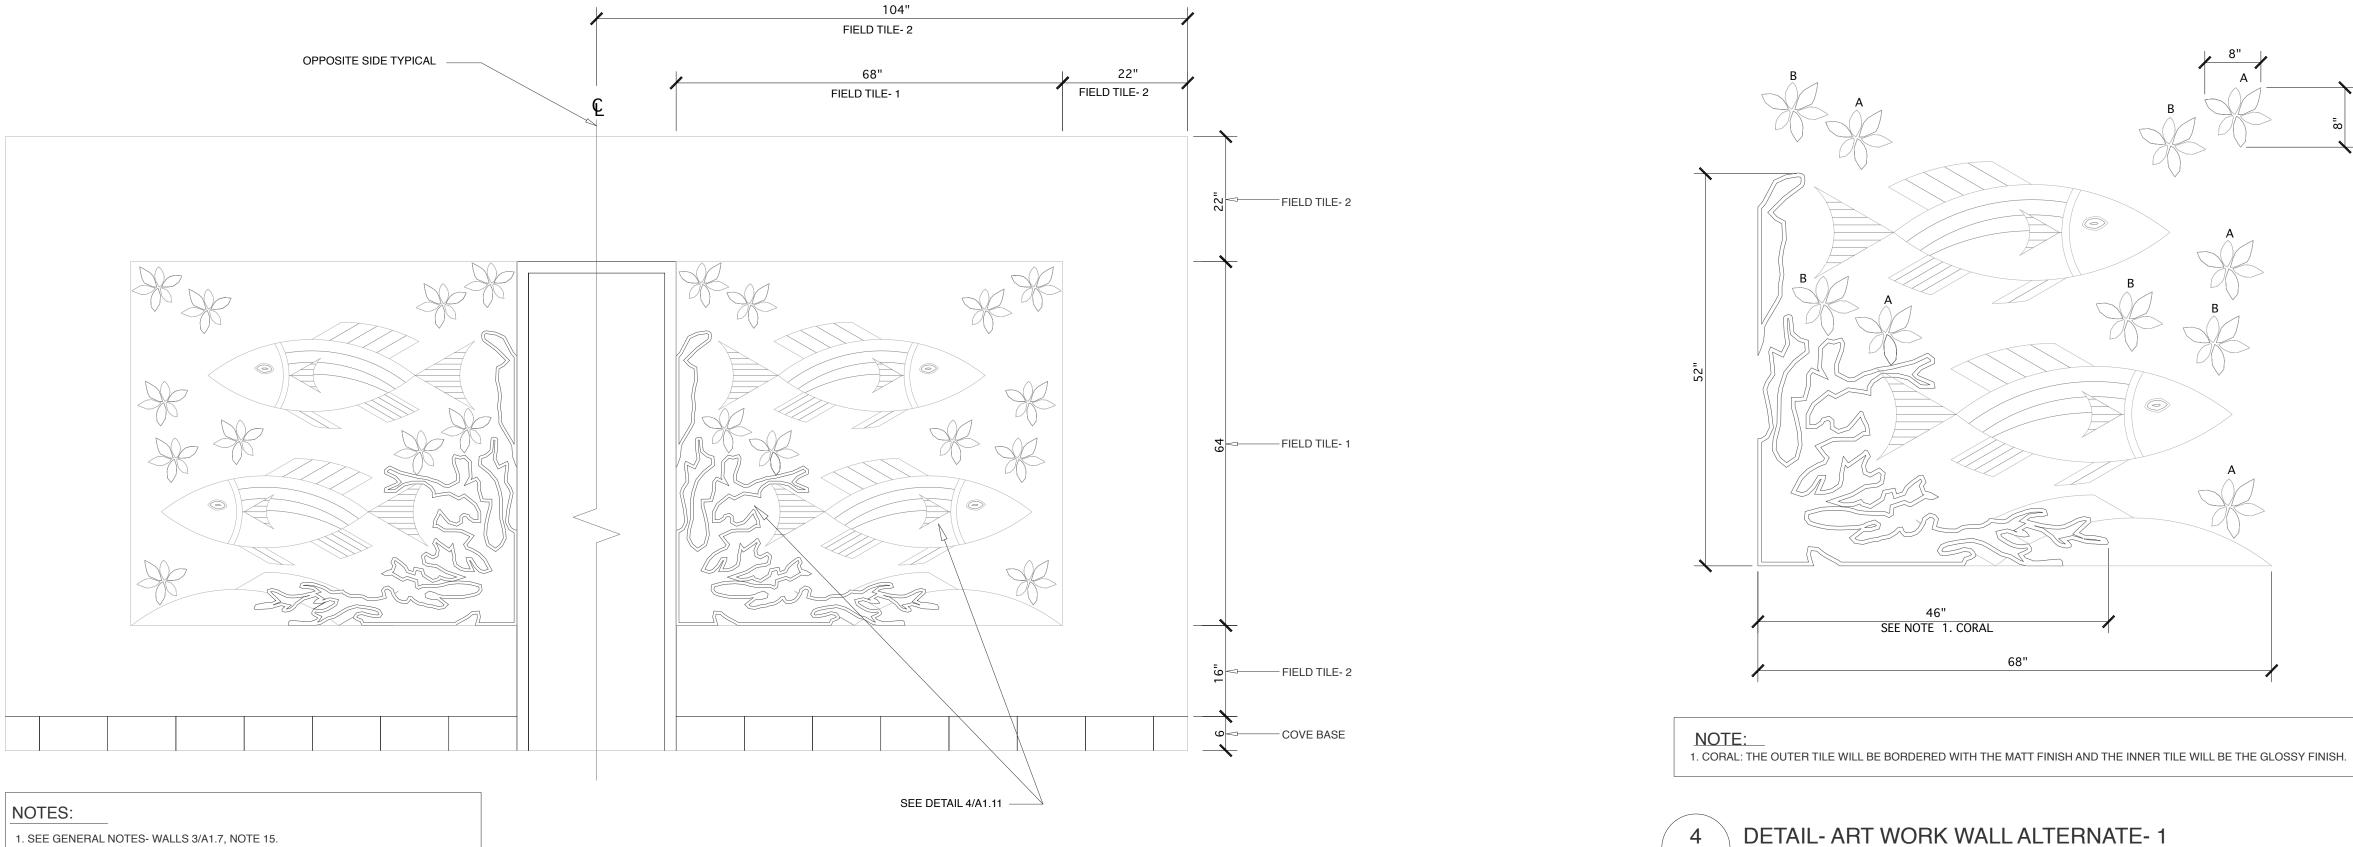
PROJECT TITLE **CARTERET COUNTY REST AREA** 3409 ARENDELL STREET MOREHEAD CITY, NORTH CAROLINA

PROJECT NO. 1604a DRAWING TITLE TILE WALL DETAIL

SHEET	13	OF	19
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PLOT DA	TE		8/11/17

ISSUE DATE	8/10/17
PLOT DATE	8/11/17

This original sheet is 22" x 34"; other dimensions indicate it has been altered.



- 2. SEE GENERAL NOTES- WALLS 3/A1.7, NOTE 18.
- 3. SEE LEGEND 2/A1.11, 3/A1.11.

4. SEE DETAIL 4/A1.11.

5. SEE ENLARGED PLAN 5/A1.11.

1 ELEV- ART WORK WALL ALTERNATE- 1 A1.11 SCALE: 3/4" = 1'-0"


MANUFACTURER	PRODUCT LINE/NAME
DALTILE	PLAZA NOVA: 6"X 12" BROWN VISION PN96.
DALTILE	JEWEL TIDE: 5/8" SUNSET PATH JT08- RANDOM MOSAIC (MESH-MOUNTED ON
DALTILE	JEWEL TIDE: 5/8" SPARKLING SAND JT01- RANDOM MOSAIC (MESH-MOUNTED
REFLECTIONS IN GLASS TILE	
	COBALT BLUE, ULTIMATE BLUE, COBALT BLUE .
	BLUE LAGOON.
	TURQUOISE GEM.
	COBALT BLUE, GLACIER WHITE, CODE RED.
	GLACIER WHITE.
	CODE RED.
	COBALT BLUE, ULTIMATE BLUE, BLUE LAGOON, GLACIER WHITE, TURQUOIS
	TURQUOISE GEM, GLACIER WHITE, BLUE LAGOON, ULTIMATE BLUE, COBALT
	GLACIER WHITE.
*	GLACIER WHITE.
REFLECTIONS IN GLASS TILE	FLORIDA ORANGE. SEE 4/A1.11 NOTE 1. CORAL.
REFLECTIONS IN GLASS TILE	NEON GREEN (MOSAIC: GLOSSY).
REFLECTIONS IN GLASS TILE	NEON GREEN (MOSAIC: matt).
REFLECTIONS IN GLASS TILE	TWILLIGHT BLUE.
	DALTILE DALTILE DALTILE REFLECTIONS IN GLASS TILE Image: state stat


2 LEGEND- TILE- ART WORK WALL ALTERNATE- 1 A1.11 SCALE: 1/4" = 1'-0"

LEGEND- PAINT/ STAIN:		
LOCATION	MANUFACTURER	PRODUCT LINE/NAME
FRAME (H.M.): PIPE CHASE WALL:	SHERWIN WILLIAMS	POSITIVE RED SW 6871
DOOR (WOOD): PIPECHASE WALL	MINIWAX	CORRAL





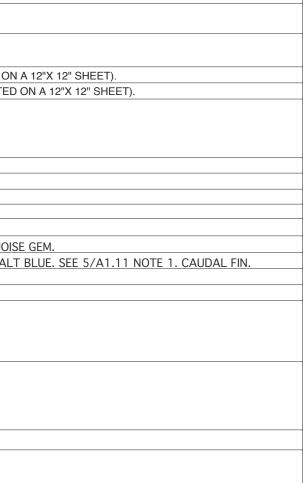

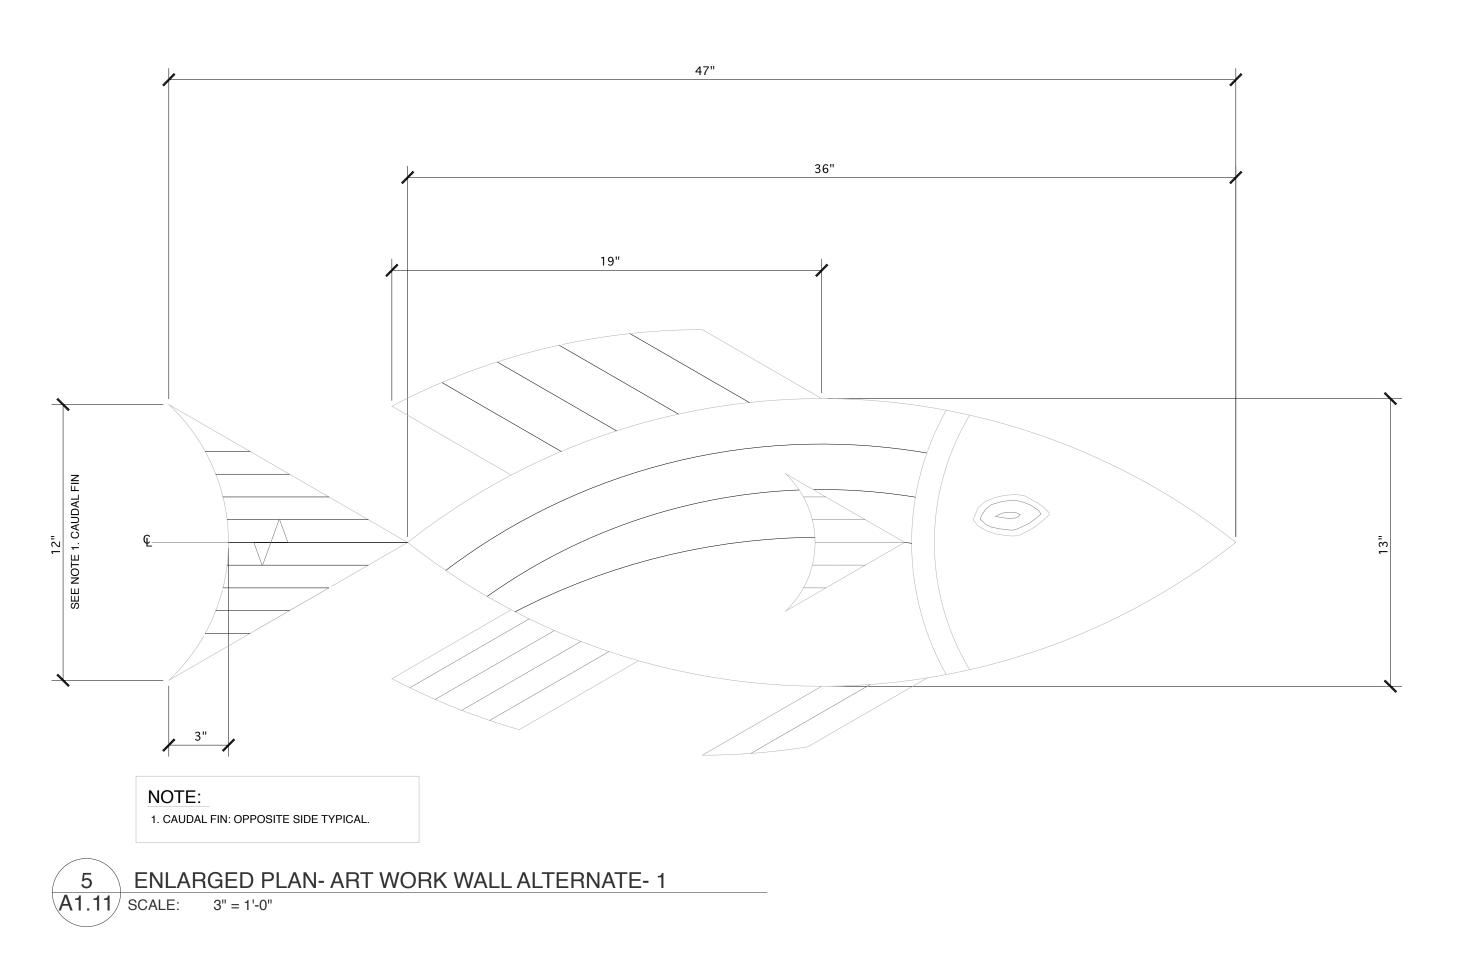

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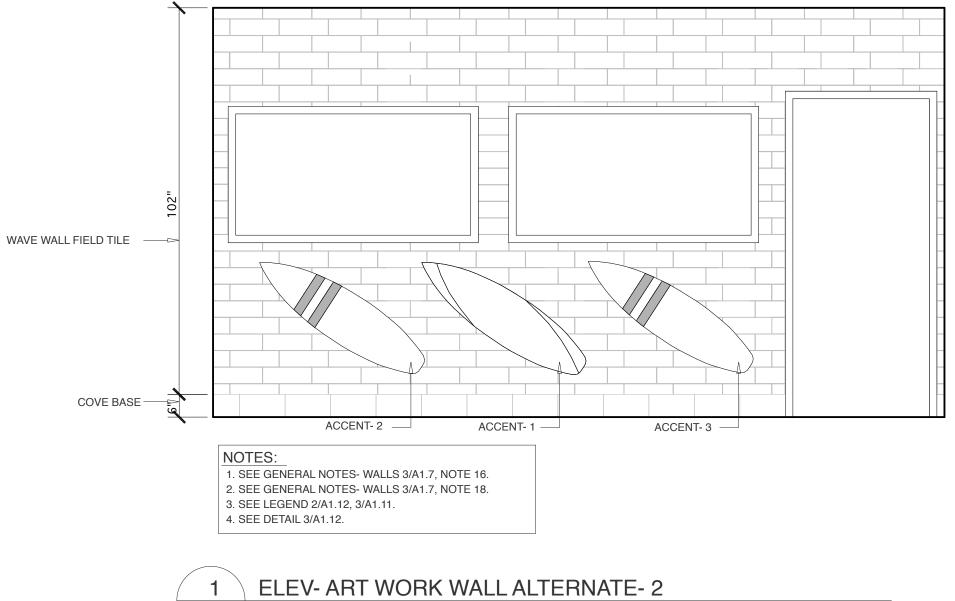


STATE ID#: 17-17533-01A WBS ELEMENT: 51213.031



A1	.11
PLOT DATE	8/11/17
ISSUE DATE	8/10/17

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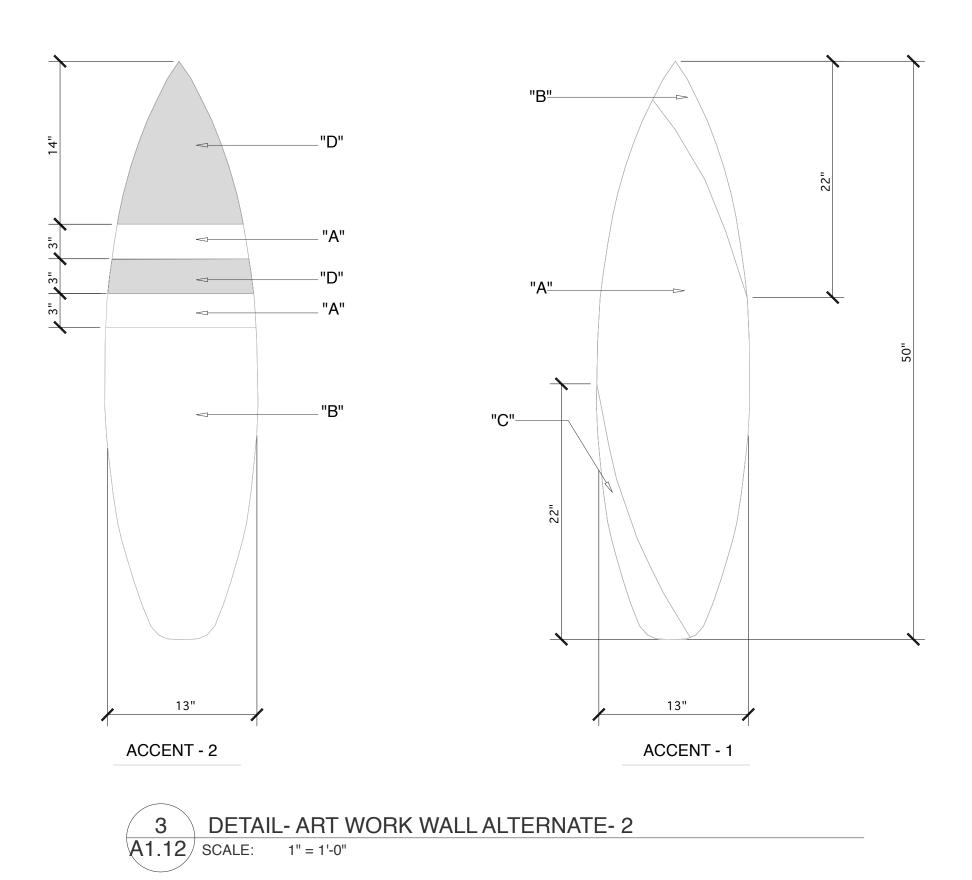
A1.12 SCALE: 1/2" = 1'-0"


LEGEND- TILE:

LEGEND- TILE.		
LOCATION	MANUFACTURER	PRODUCT LINE/NAME
DISPLAT CASE- 2 WALL	_	
COVE BASE:	DALTILE	PLAZA NOVA: 6"X 12" BROWN VISION PN96.
WAVE WALL FIELD TILE:	DALTILE	MODERN DIMENSIONS: 4-1/4"X 12-3/4" AQUA GLOW
ACCENT- 1:		
"A":	AMERICAN OLEAN	UNGLAZED CERAMIC MOSAICS: 1" ICE WHITE A25- ROUNDED CORNER BRICKWORK.
"B":	AMERICAN OLEAN	UNGLAZED CERAMIC MOSAICS: 1" ANTIQUE ROSE A11- ROUNDED CORNER BRICKWORK.
"C":	AMERICAN OLEAN	UNGLAZED CERAMIC MOSAICS: 1" PEACOCK BLUE A08- ROUNDED CORNER BRICKWORK.
ACCENT- 2:		
"A":	AMERICAN OLEAN	UNGLAZED CERAMIC MOSAICS: 1" ICE WHITE A25- ROUNDED CORNER BRICKWORK.
"B":	AMERICAN OLEAN	UNGLAZED CERAMIC MOSAICS: 1" ANTIQUE ROSE A11- ROUNDED CORNER BRICKWORK.
"D":	AMERICAN OLEAN	UNGLAZED CERAMIC MOSAICS: 1" ANTIQUE ROSE SPECKLED A11- ROUNDED CORNER BRICKWORK.
ACCENT- 3:		
"A":	AMERICAN OLEAN	UNGLAZED CERAMIC MOSAICS: 1" ICE WHITE A25- ROUNDED CORNER BRICKWORK.
"C":	AMERICAN OLEAN	UNGLAZED CERAMIC MOSAICS: 1" PEACOCK BLUE A08- ROUNDED CORNER BRICKWORK.
"E":	AMERICAN OLEAN	UNGLAZED CERAMIC MOSAICS: 1" BIMINI BLUE SPECKLED A85- ROUNDED CORNER BRICKWORK.



2 LEGEND- TILE- ART WORK WALL ALTERNATE- 2 A1.12 SCALE: 1/4" = 1'-0"



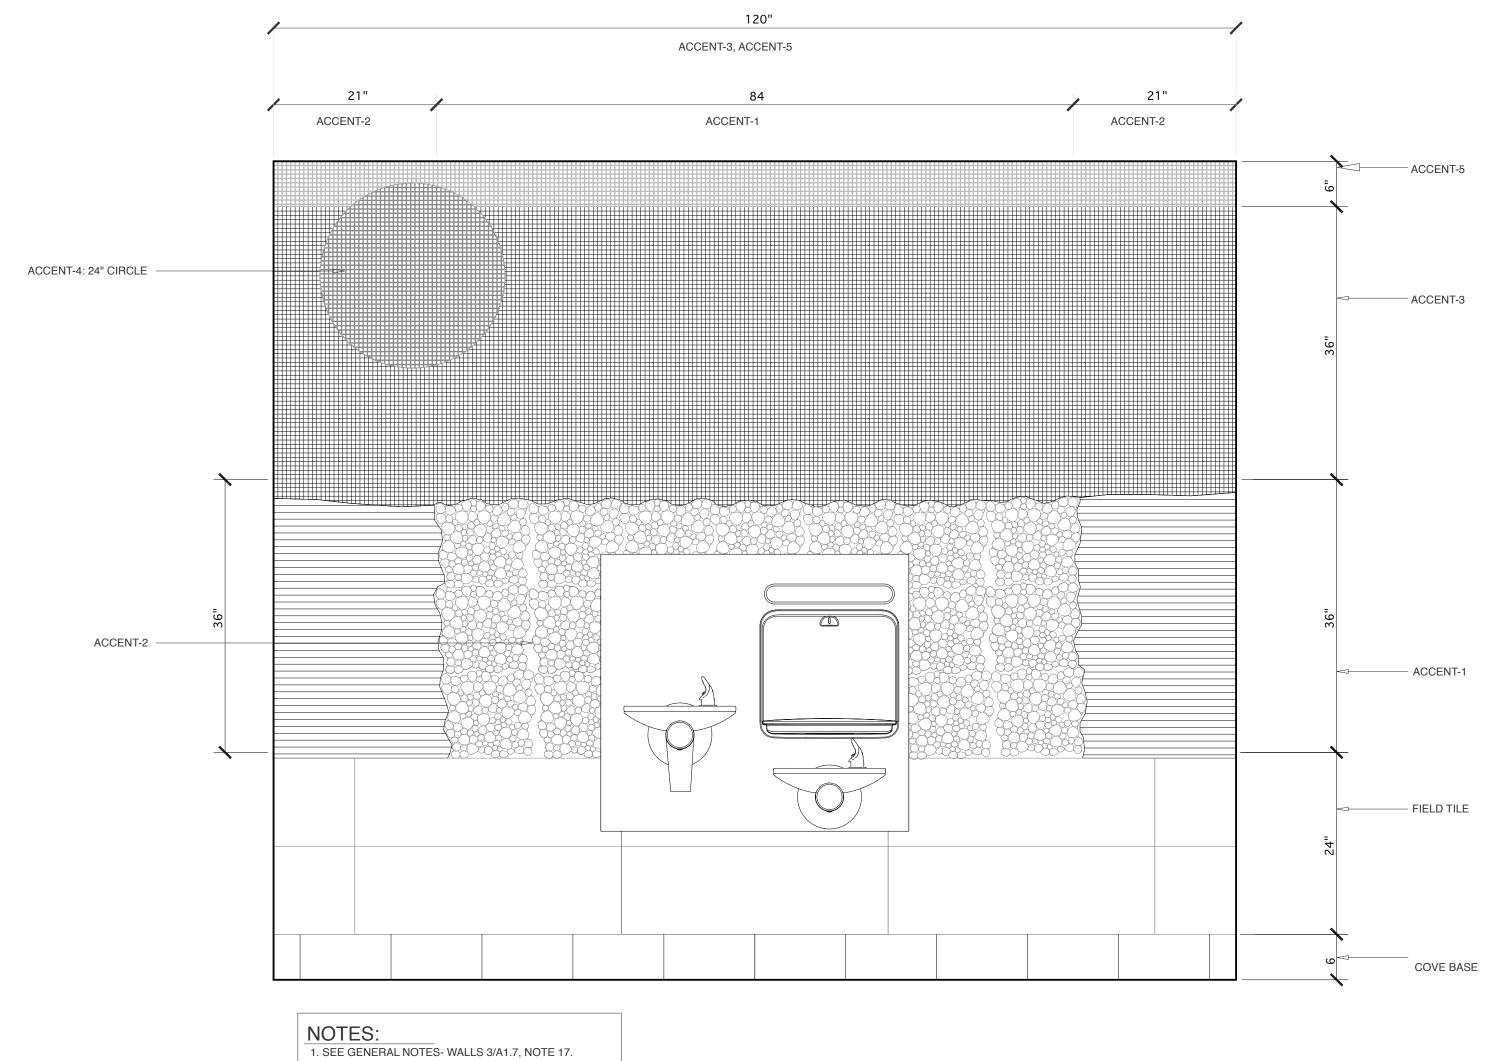


2. SEE GENERAL NOTES- WALLS 3/A1.7, NOTE 18. 3. SEE LEGEND 5/A1.12.

> ELEV- ART WORK WALL ALTERNATE- 3 4 A1.12 SCALE: 1" = 1'-0"



LOCATION	MANUFACTURER	PRODUCT LINE/NAME
WATER FOUNTAIN WALL:		
COVE BASE:	DALTILE	PLAZA NOVA: 6"X 12" BROWN VISION PN96.
FIELD TILE:	DALTILE	RIVER MARBLE: 12"X 36" SANDY FLATS RM91- POLISHED.
ACCENT- 1:	DALTILE	FASHION ACCENTS: 12"X 12" BROWN PEBBLE F018- DECORATIVE ACCENT.
ACCENT- 2:	DALTILE	REFLECTIONS IN GLASS TILE: 1"X 6" BLUE LAGOON- GLOSSY/ MATT FINISH- MESH-MOUNTED.
ACCENT- 3:	DALTILE	UPTOWN GLASS: (PEARL METRO & EXOTIC): 1"X 1" PEARL BLUE UP15- MESH-MOUNTED ON A 12"X 12" SHEET.
ACCENT- 4:	DALTILE	COLORWAVE: 1"X 1" ICE WHITE CW01-MESH-MOUNTED ON A 12"X 12" SHEET.
ACCENT- 5:	DALTILE	JEWEL TIDE: 5/8" SPARKLING SAND JT01- RANDOM MOSAIC (MESH-MOUNTED ON A 12"X 12" SHEET).

5 LEGEND- TILE- ART WORK WALL ALTERNATE- 3 A1.12 SCALE: 1/4" = 1'-0"

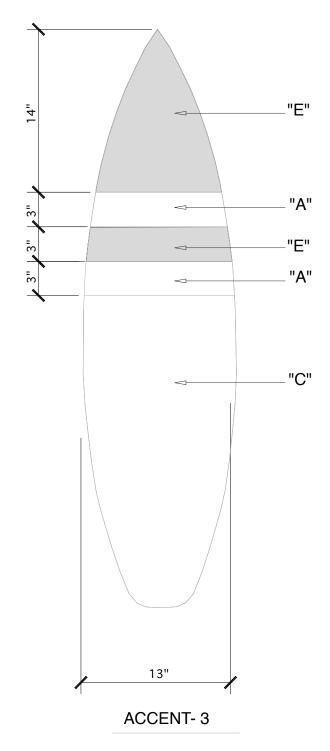

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PROJECT TITLE **CARTERET COUNTY REST AREA** 3409 ARENDELL STREET MOREHEAD CITY, NORTH CAROLINA


PROJECT NO. 1604a DRAWING TITLE


TILE ART-ALT. 2&3

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SHEET	15	OF	19

PLOT DATE	8/11/17
ISSUE DATE	8/10/17


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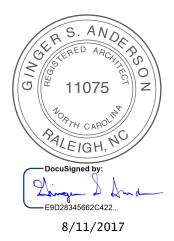
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PROJECT NO. 1604a DRAWING TITLE SECTIONS

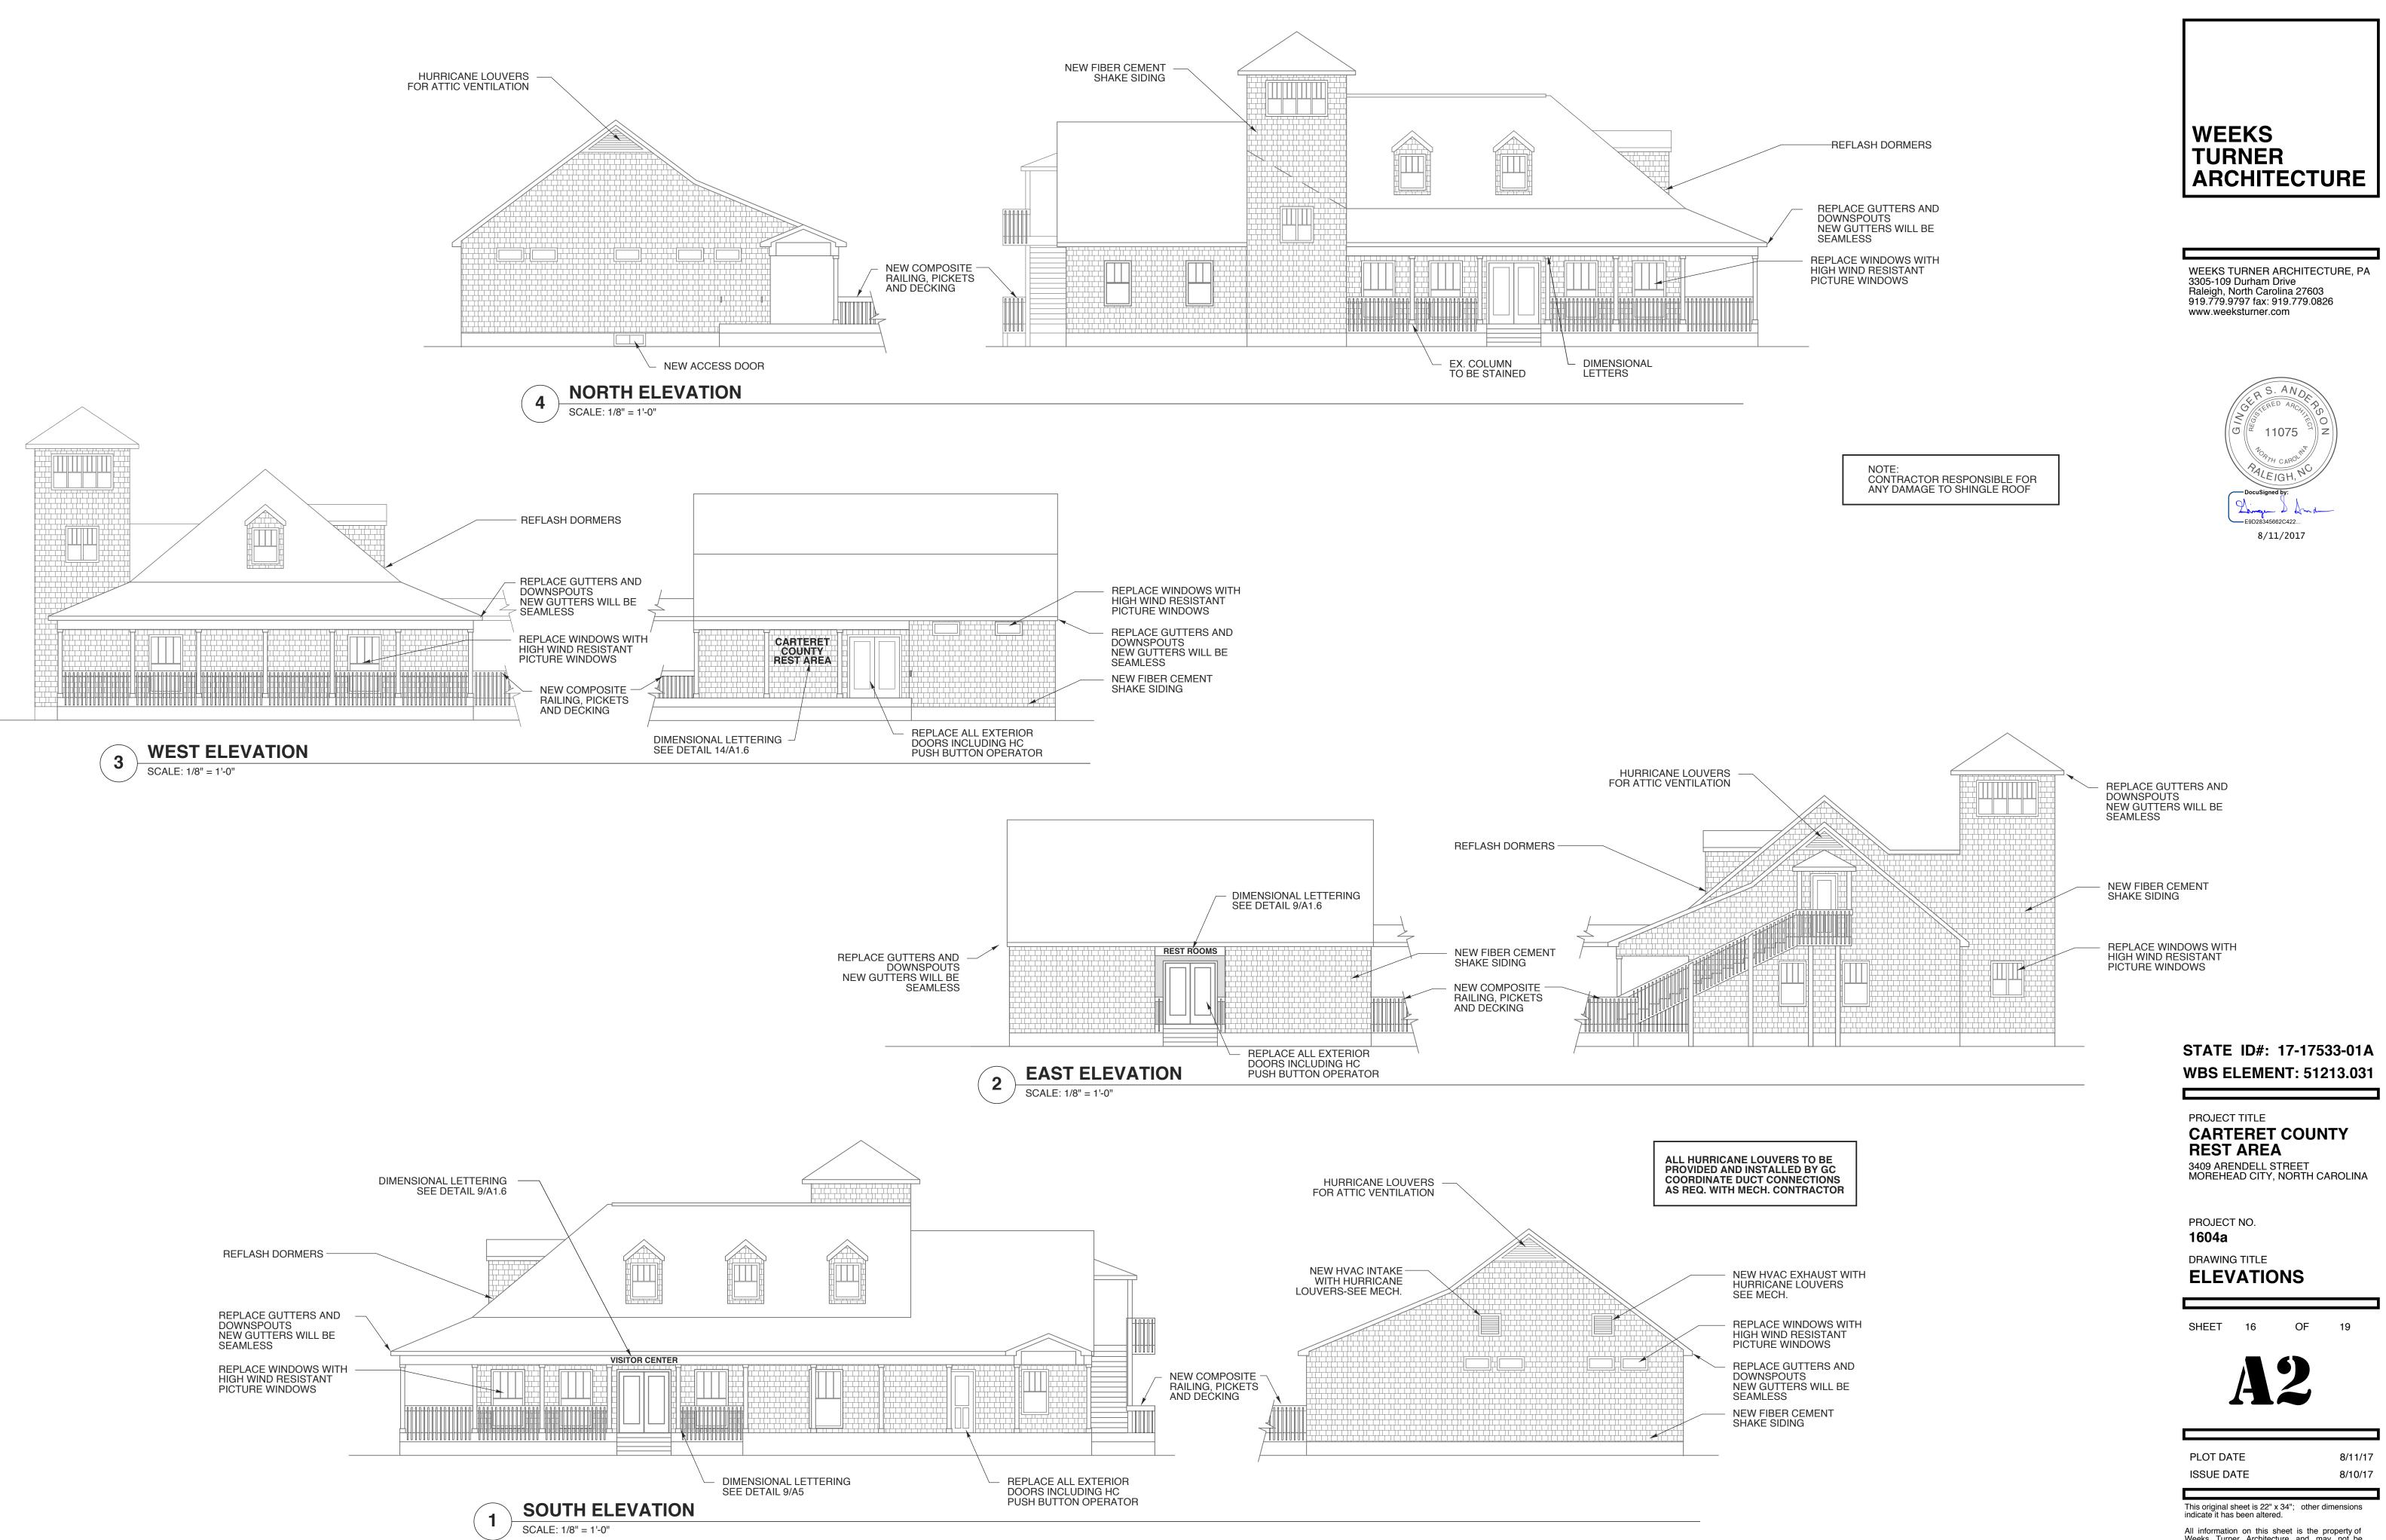
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WINDOW SCHEDULE	DOOR SCHEDULE	ROOM FINISH SCHEDULE
	DOOR FRAME	MARK ROOM NAME FLOOR BASE WALL WAINSCOT CEILING REMARKS / NOTES
MARK W SIZE H TYPE MATERIAL GLASS REMARKS	MARK SIZE MAT'L TYPE TYPE DETAILS HDWR SET NO. REMARKS	N E S W WAINSCOT MATERIAL HGT.
A 3'-6" x 6'-6" 1 ALUM CLAD WOOD 1" INSUL. LOW E GLASS FIXED	1 6'-0" x 7'-0" x 1-3/4" ALUM A A 2 WHITE TYP AT SF	101 LOBBY TILE TILE PTD. DW. EXIST. REPLACE SHEET ROCK AT CLG.
B 3'-0" x 4'-0" 2 ALUM CLAD WOOD 1" INSUL. LOW E GLASS FIXED - BLACK OUT / TINTED GLASS-TO BE CONFIRMED	2 6'-0" x 7'-0" x 1-3/4" ALUM A A 2	102 MEN 1 TILE TILE TILE TILE TILE PTD. DW. EXIST. REPLACE SHEET ROCK AT CLG. REMOVE SHEATHING @ SINK/TOILET
C 3'-0" x 5'-0" 3 ALUM CLAD WOOD 1" INSUL. LOW E GLASS FIXED	3 3'-0" x 7'-0" x 1-3/4" FIBERGLASS E B 5	103 PIPE CHASE TILE NEW PLYWOOD TO BE PTD. PTD. DW. EXIST.
D 2'-0" x 4'-0" 4 ALUM CLAD 1" INSUL. LOW E GLASS FIXED	4 6'-0" x 7'-0" x 1-3/4" ALUM. A A 1	104 MEN 2 TILE TILE TILE PTD. DW. EXIST. REPLACE SHEET ROCK AT CLG. REMOVE SHEATHING @ SINK/TOILET
E 2'-0" x 4'-0" 5 ALUM CLAD WOOD 1" INSUL. LOW E GLASS FIXED - OBSCURE GLASS	5 6'-0" x 7'-0" x 1-3/4" ALUM. A A 2	105 FAMILY RESTROOM TILE TILE SEE ELEV. PTD. DW. EXIST. REPLACE SHEET ROCK AT CLG. REMOVE SHEATHING @ SINK/TOILET
F 3'-0" x 1'-6" 6 ALUM CLAD WOOD 1" INSUL. LOW E GLASS FIXED	6 3'-0" x 7'-0" x 1-3/4" SC WOOD B B 3 CLOSER FOR 90 DEGREE STOP	106 JANITOR TILE NEW PLYWOOD TO BE PTD. PTD. DW. EXIST. REPLACE SHEET ROCK AT CLG.
	7 3'-0" x 7'-0" x 1-3/4" SC WOOD C B 5	107 STORAGE TILE NEW PLYWOOD TO BE PTD. PTD. DW. EXIST. REPLACE SHEET ROCK AT CLG.
NOTES: -SEE WINDOW TYPE ELEVATIONS AND DETAILS.	8 3'-0" x 7'-0" x 1-3/4" SC WOOD D B 3	108 WOMEN 2 TILE TILE TILE PTD. DW. EXIST. REPLACE SHEET ROCK AT CLG. REMOVE SHEATHING @ SINK/TOILET
-FIELD VERIFY ALL EXISTING OPENING SIZES. DIMENSIONS GIVEN FOR REFERENCE. -INCLUDE THERMAL BREAK PER MANUFACTURER'S STANDARDS WITH ALL FRAMES. -ALL WINDOWS TO MEET NCSBC SECTION 1609.1.2	9 2'-0" x 7'-0" x 1-3/4" SC WOOD D B 4	109 PIPE CHASE TILE NEW PLYWOOD TO BE PTD. PTD. DW. EXIST.
-ALL WINDOWS TO MEET NOSDO SECTION 1009.1.2	10 2'-0" x 7'-0" x 1-3/4" SC WOOD D B 4	Image: 110 WOMEN 1 TILE TILE TILE TILE PTD. DW. EXIST. REPLACE SHEET ROCK AT CLG. REMOVE SHEATHING @ SINK/TOILET
	11 9'-0" x 8'-0" x 1-3/4" FIBERGLASS F MATCH EXISTING OPENING	111 VISITOR CENTER - existing finishes to remain; repair and paint as needed for replacement of windows
	12 3'-0" x 7'-0" x 1-3/4" FIBERGLASS E B 5	112 SERVICE COUNTER existing finishes to remain; repair and paint as needed for replacement of windows existing finishes to remain; repair and paint as needed for replacement of windows existing finishes to remain; repair and paint as needed for replacement of windows existing finishes to remain; repair and paint as needed for replacement of windows existing finishes to remain; repair and paint as needed for replacement of windows existing finishes to remain; repair and paint as needed for replacement of windows existing finishes to remain; repair and paint as needed for replacement of windows existing finishes to remain; repair and paint as needed for replacement of windows existing finishes to remain; repair and paint as needed for replacement of windows existing finishes to remain; repair and paint as needed for replacement of windows existing finishes to remain; repair and paint as needed for replacement of windows existing finishes to remain; repair and paint as needed for replacement of windows existing finishes to remain; repair and paint as needed for replacement of windows existing finishes to remain; repair and paint as needed for replacement of windows existing finishes to remain; repair and paint as needed for replacement of windows existing finishes to remain; repair and paint as needed for replacement of windows existing finishes to remain; repair and paint as needed for replacement of windows existing finishes to remain; repair and paint as needed for replacement of windows existing finishes to remain; repair and paint as needed for replacement of windows existing finishes to remain; repaint as needed for replacement of windows
		113 STAFF RESTROOM existing finishes to remain; repair and paint as needed for replacement of windows existing finishes to remain; repair and paint as needed for replacement of windows existing finishes to remain; repair and paint as needed for replacement of windows existing finishes to remain; repair and paint as needed for replacement of windows existing finishes to remain; repair and paint as needed for replacement of windows existing finishes to remain; repair and paint as needed for replacement of windows existing finishes to remain; repair and paint as needed for replacement of windows existing finishes to remain; repair and paint as needed for replacement of windows existing finishes to remain; repair and paint as needed for replacement of windows existing finishes to remain; repair and paint as needed for replacement of windows existing finishes to remain; repair and paint as needed for replacement of windows existing finishes to remain; repair and paint as needed for replacement of windows existing finishes to remain; repair and paint as needed for replacement of windows existing finishes to remain; repair and paint as needed for replacement of windows existing finishes to remain; repair and paint as needed for replacement of windows existing finishes to remain; repair and paint as needed for replacement of windows existing finishes to remain; repair and paint as needed for replacement of windows existing finishes to remain; repair and paint as needed for replacement of windows existing finishes to remain; repair and paint as needed for replacement of windows existing finishes to remain; repair and paint as needed for replacement of windows
	NOTES: HARDWARE SETS	114 STORAGE existing finishes to remain; repair and paint as needed for replacement of windows existing finishes to remain; repair and paint as needed for replacement of windows existing finishes to remain; repair and paint as needed for replacement of windows existing finishes to remain; repair and paint as needed for replacement of windows existing finishes to remain; repair and paint as needed for replacement of windows existing finishes to remain; repair and paint as needed for replacement of windows existing finishes to remain; repair and paint as needed for replacement of windows existing finishes to remain; repair and paint as needed for replacement of windows existing finishes to remain; repair and paint as needed for replacement of windows existing finishes to remain; repair and paint as needed for replacement of windows existing finishes to remain; repair and paint as needed for replacement of windows existing finishes to remain; repair and paint as needed for replacement of windows existing finishes to remain; repair and paint as needed for replacement of windows existing finishes to remain; repair and paint as needed for replacement of windows existing finishes to remain; repair and paint as needed for replacement of windows existing finishes to remain; repair and paint as needed for replacement of windows existing finishes to remain; repair and paint as needed for replacement of windows existing finishes to remain; repair and paint as needed for replacement of windows existing finishes to remain; repair and paint as needed for replacement of windows existing finishes to remain; repaint as needed for replacement of windows
	1. ADA DOOR OPERATOR WITH PUSH PAD	115 OFFICE existing finishes to remain; repair and paint as needed for replacement of windows existing finishes to remain; repair and paint as needed for replacement of windows existing finishes to remain; repair and paint as needed for replacement of windows existing finishes to remain; repair and paint as needed for replacement of windows existing finishes to remain; repair and paint as needed for replacement of windows existing finishes to remain; repair and paint as needed for replacement of windows existing finishes to remain; repair and paint as needed for replacement of windows existing finishes to remain; repair and paint as needed for replacement of windows existing finishes to remain; repair and paint as needed for replacement of windows existing finishes to remain; repair and paint as needed for replacement of windows existing finishes to remain; repair and paint as needed for replacement of windows existing finishes to remain; repair and paint as needed for replacement of windows existing finishes to remain; repair and paint as needed for replacement of windows existing finishes to remain; repair and paint as needed for replacement of windows existing finishes to remain; repair and paint as needed for replacement of windows existing finishes to remain; repair and paint as needed for replacement of windows existing finishes to remain; repair and paint as needed for replacement of windows existing finishes to remain; repair and paint as needed for replacement of windows existing finishes to remain; repair and paint as needed for replacement of windows existing finishes to remain; repair and paint as needed for replacement of windows
	- COORDINATE KEYING OF HARDWARE WITH OWNER2.PUSH PULL HARWARE WITH CLOSER- DOOR HANDLES TO BE LEVER HANDLE3.PASSAGE WITH CLOSER4.ADA CUP PULL WITH CLOSER	116 OFFICE existing finishes to remain; repair and paint as needed for replacement of windows existing finishes to remain; repair and paint as needed for replacement of windows existing finishes to remain; repair and paint as needed for replacement of windows existing finishes to remain; repair and paint as needed for replacement of windows existing finishes to remain; repair and paint as needed for replacement of windows existing finishes to remain; repair and paint as needed for replacement of windows existing finishes to remain; repair and paint as needed for replacement of windows existing finishes to remain; repair and paint as needed for replacement of windows existing finishes to remain; repair and paint as needed for replacement of windows existing finishes to remain; repair and paint as needed for replacement of windows existing finishes to remain; repair and paint as needed for replacement of windows existing finishes to remain; repair and paint as needed for replacement of windows existing finishes to remain; repair and paint as needed for replacement of windows existing finishes to remain; repair and paint as needed for replacement of windows existing finishes to remain; repair and paint as needed for replacement of windows existing finishes to remain; repair and paint as needed for replacement of windows existing finishes to remain; repair and paint as needed for replacement of windows existing finishes to remain; repair and paint as needed for replacement of windows existing finishes to remain; repair and paint as needed for replacement of windows existing finishes to remain; repair and paint as needed for replacement of windows
	-1 MASTER KEY 5. LOCKSET WITH CLOSER	117 OFFICE existing finishes to remain; repair and paint as needed for replacement of windows existing finishes to remain; repair and paint as needed for replacement of windows existing finishes to remain; repair and paint as needed for replacement of windows existing finishes to remain; repair and paint as needed for replacement of windows existing finishes to remain; repair and paint as needed for replacement of windows existing finishes to remain; repair and paint as needed for replacement of windows existing finishes to remain; repair and paint as needed for replacement of windows existing finishes to remain; repair and paint as needed for replacement of windows existing finishes to remain; repair and paint as needed for replacement of windows existing finishes to remain; repair and paint as needed for replacement of windows existing finishes to remain; repair and paint as needed for replacement of windows existing finishes to remain; repair and paint as needed for replacement of windows existing finishes to remain; repair and paint as needed for replacement of windows existing finishes to remain; repair and paint as needed for replacement of windows existing finishes existigos existing finishes
	- ALL DOORS TO MEET NCSBC SECTION 1609.1.2 SEE SPEC FOR REMAINDER OF HARDWARE	118 BREAK ROOM existing finishes to remain; repair and paint as needed for replacement of windows existing finishes to remain; repair and paint as needed for replacement of windows existing finishes to remain; repair and paint as needed for replacement of windows existing finishes to remain; repair and paint as needed for replacement of windows existing finishes to remain; repair and paint as needed for replacement of windows existing finishes to remain; repair and paint as needed for replacement of windows existing finishes to remain; repair and paint as needed for replacement of windows existing finishes to remain; repair and paint as needed for replacement of windows existing finishes to remain; repair and paint as needed for replacement of windows existing finishes to remain; repair and paint as needed for replacement of windows existing finishes to remain; repair and paint as needed for replacement of windows existing finishes to remain; repair and paint as needed for replacement of windows existing finishes to remain; repair and paint as needed for replacement of windows existing finishes existing finis
		119 COVERED PORCH WD. DECK existing existing EXIST. EXIST.
		SEE FINISH PLAN (A1.4), INT. ELEVATIONS (A1.5) AND A1.7-A1.12 FOR MORE INFORMATION ON FINISHES.

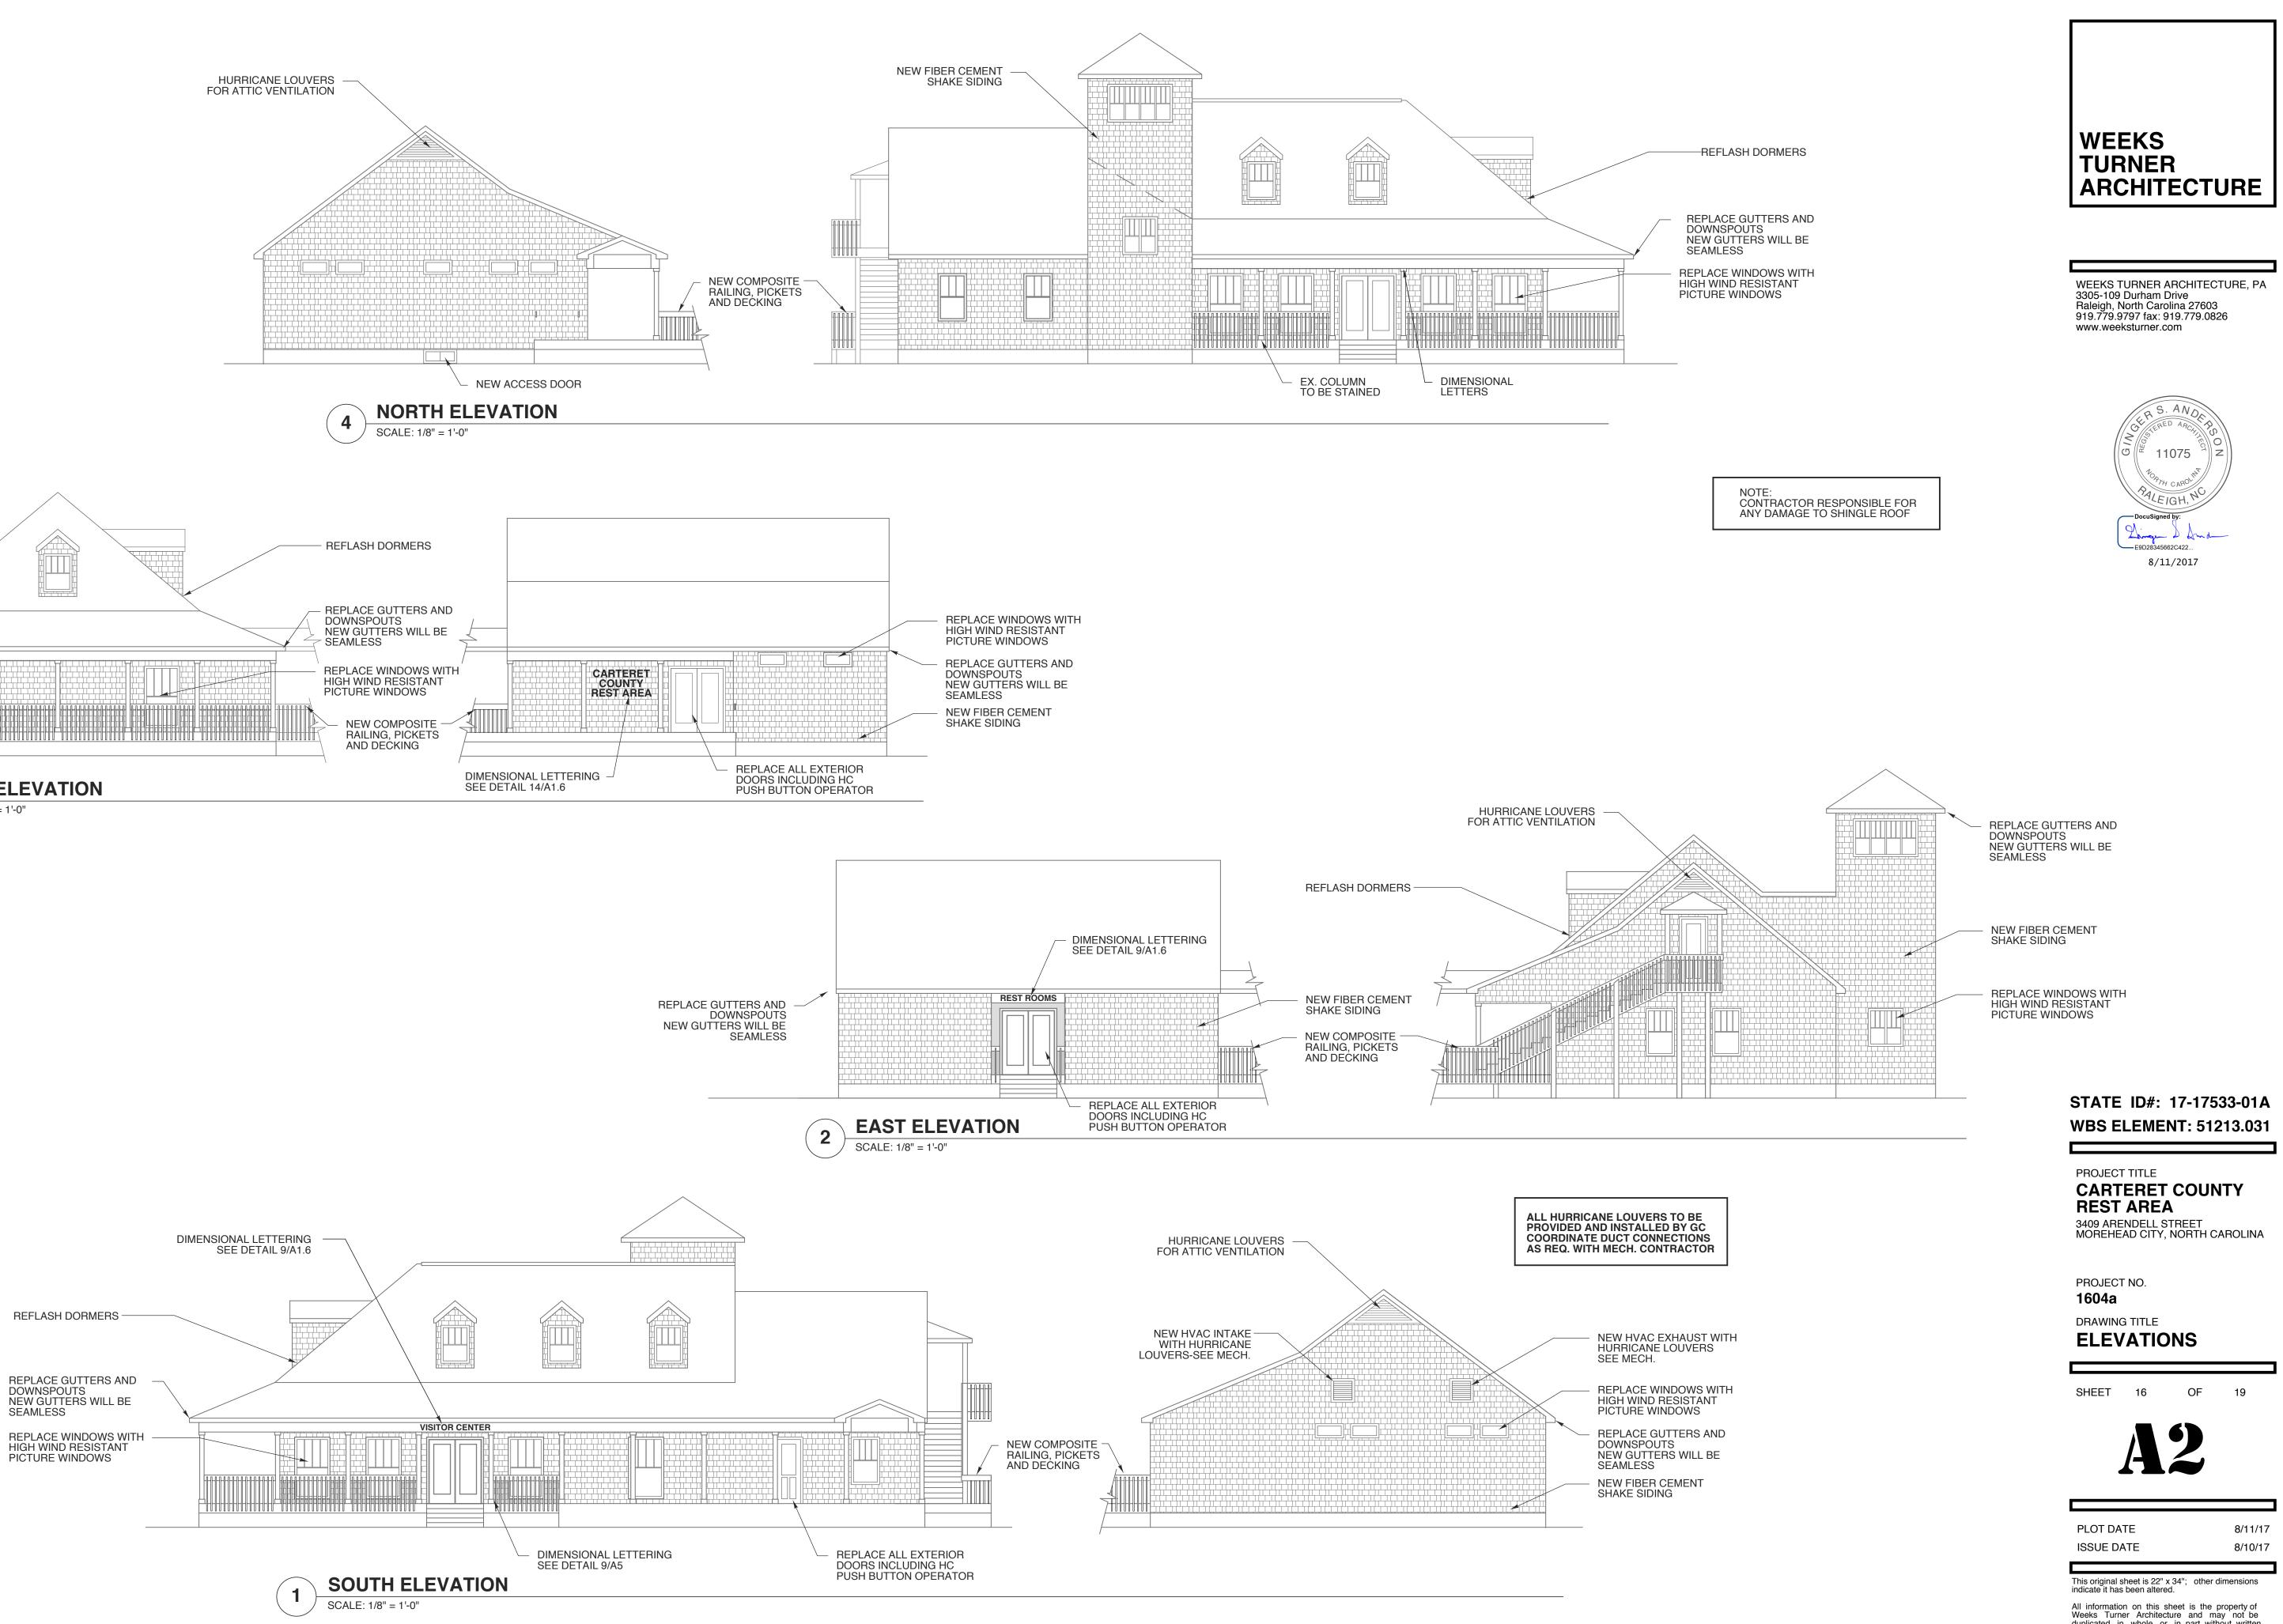



LAP OVER FLASHING

COPPER FLASHING FIBER CEMENT TRIM
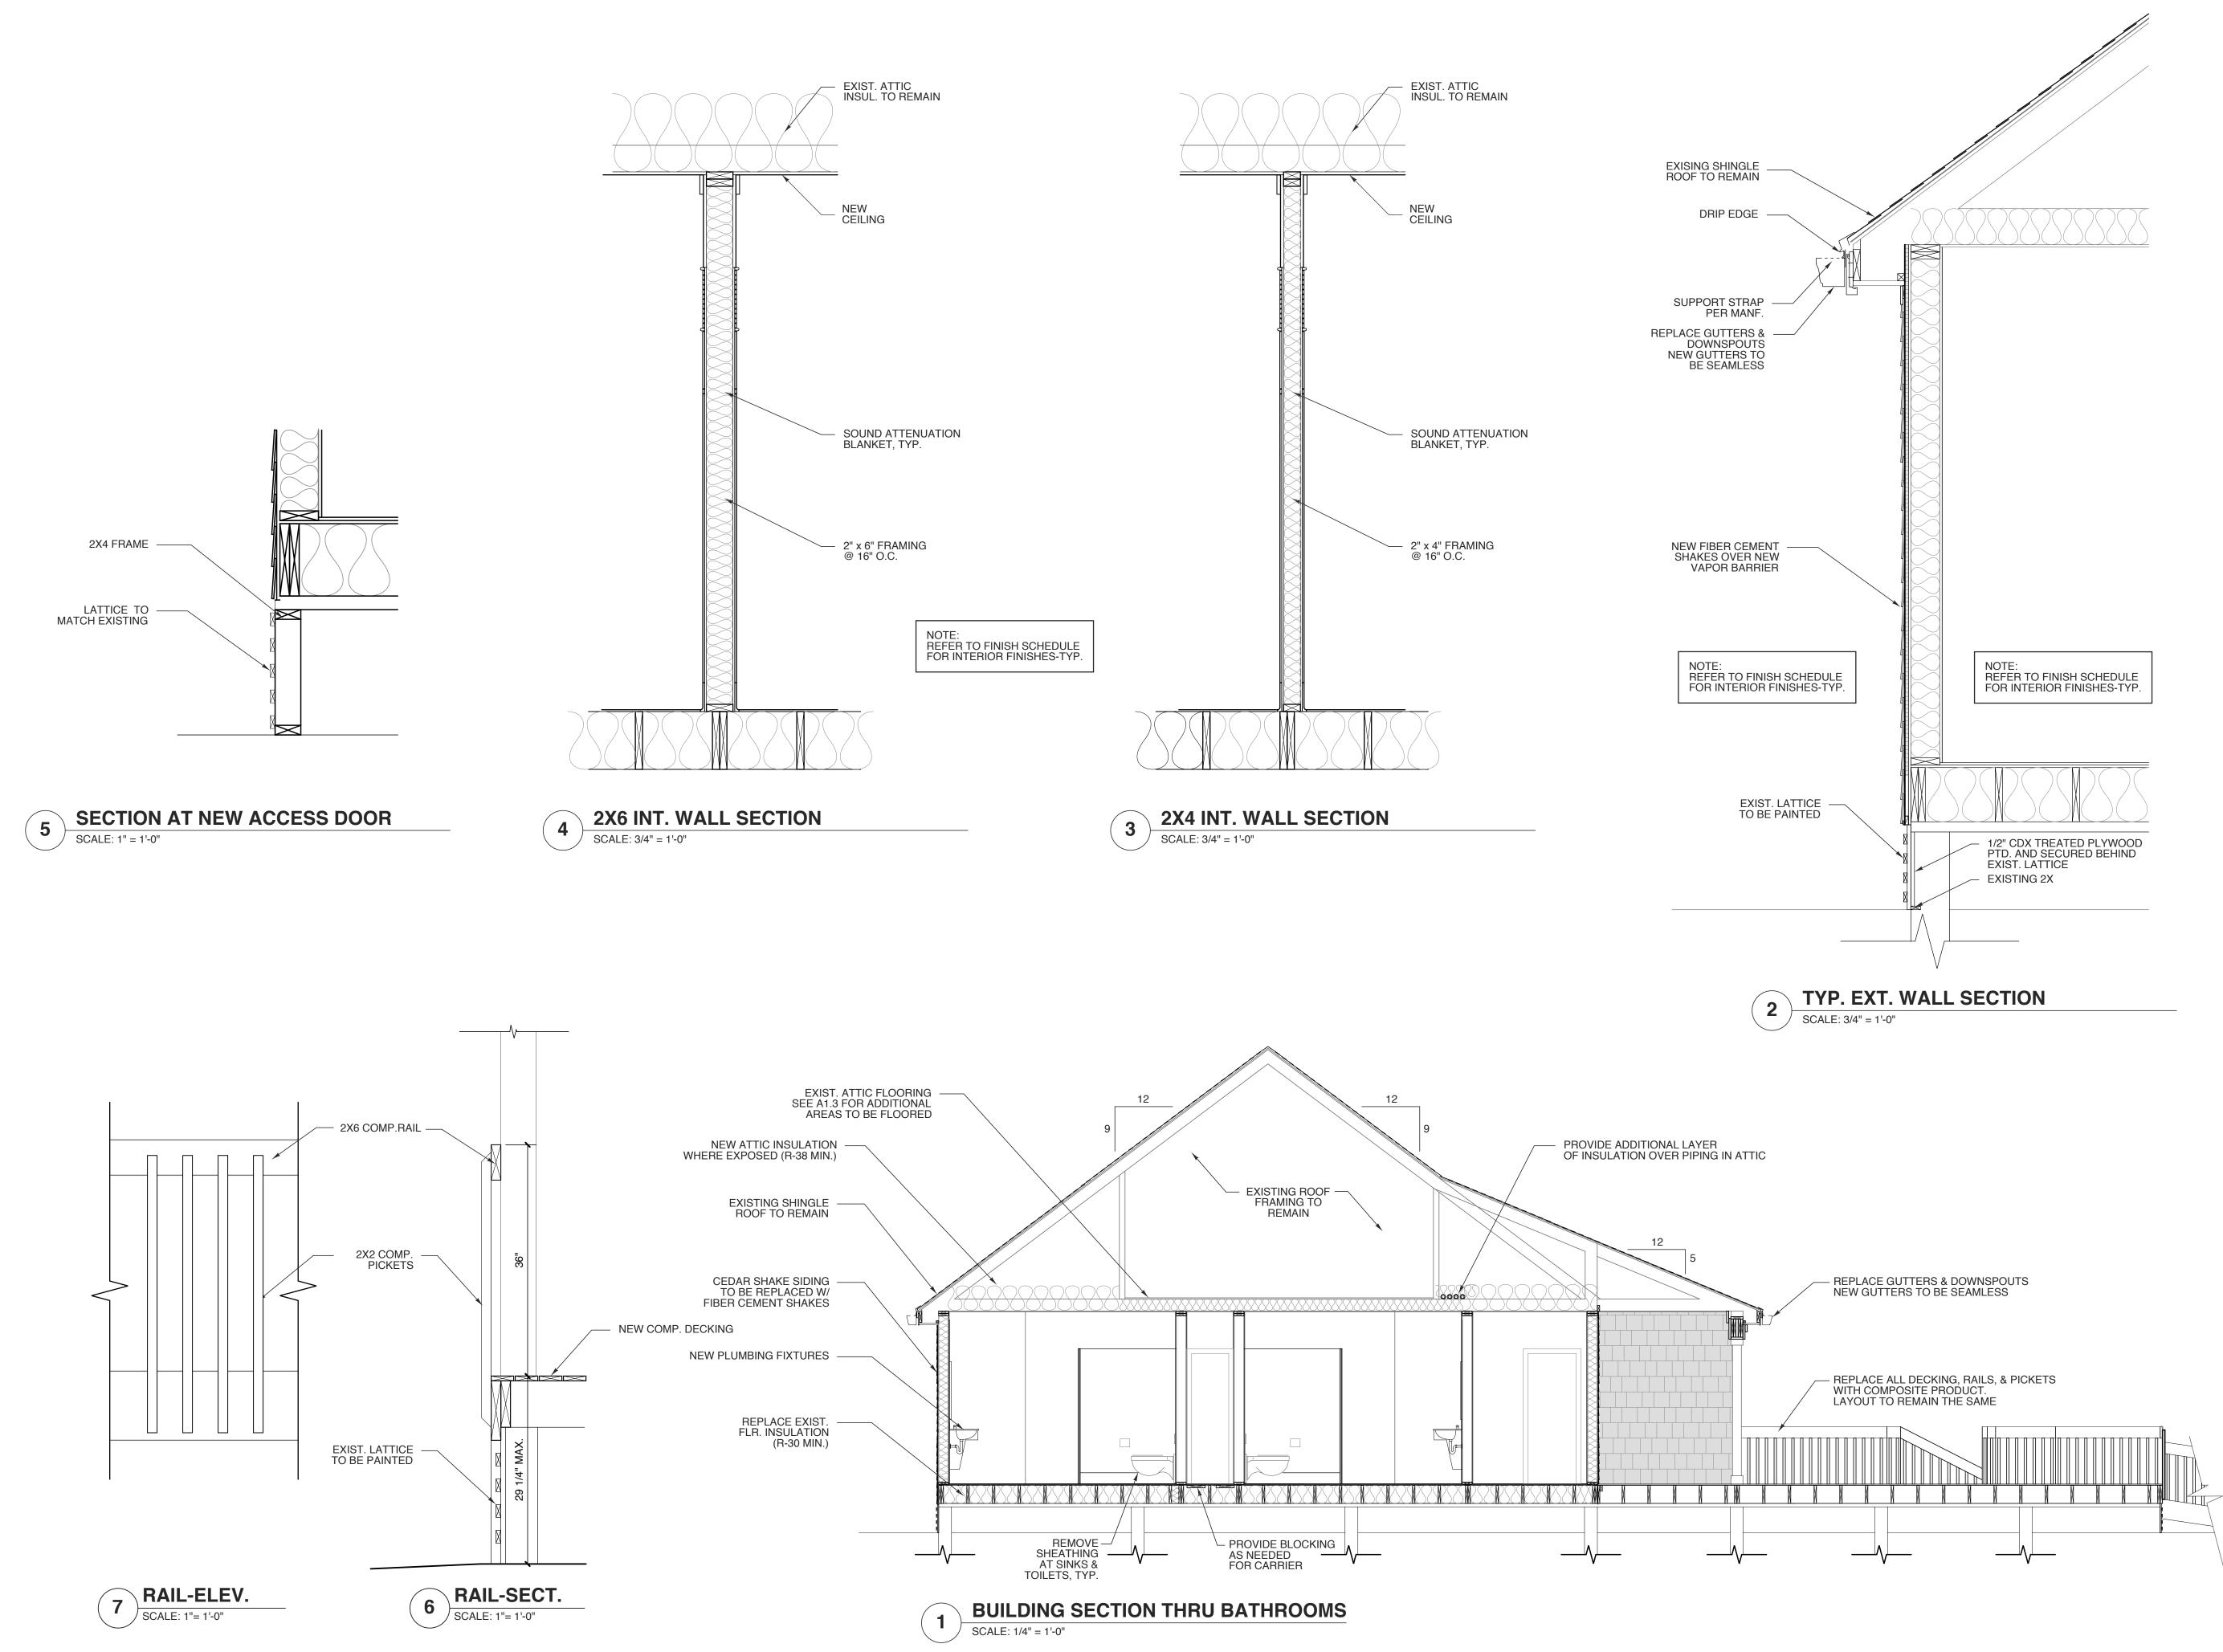
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PROJECT TITLE **CARTERET COUNTY REST AREA** 3409 ARENDELL STREET MOREHEAD CITY, NORTH CAROLINA

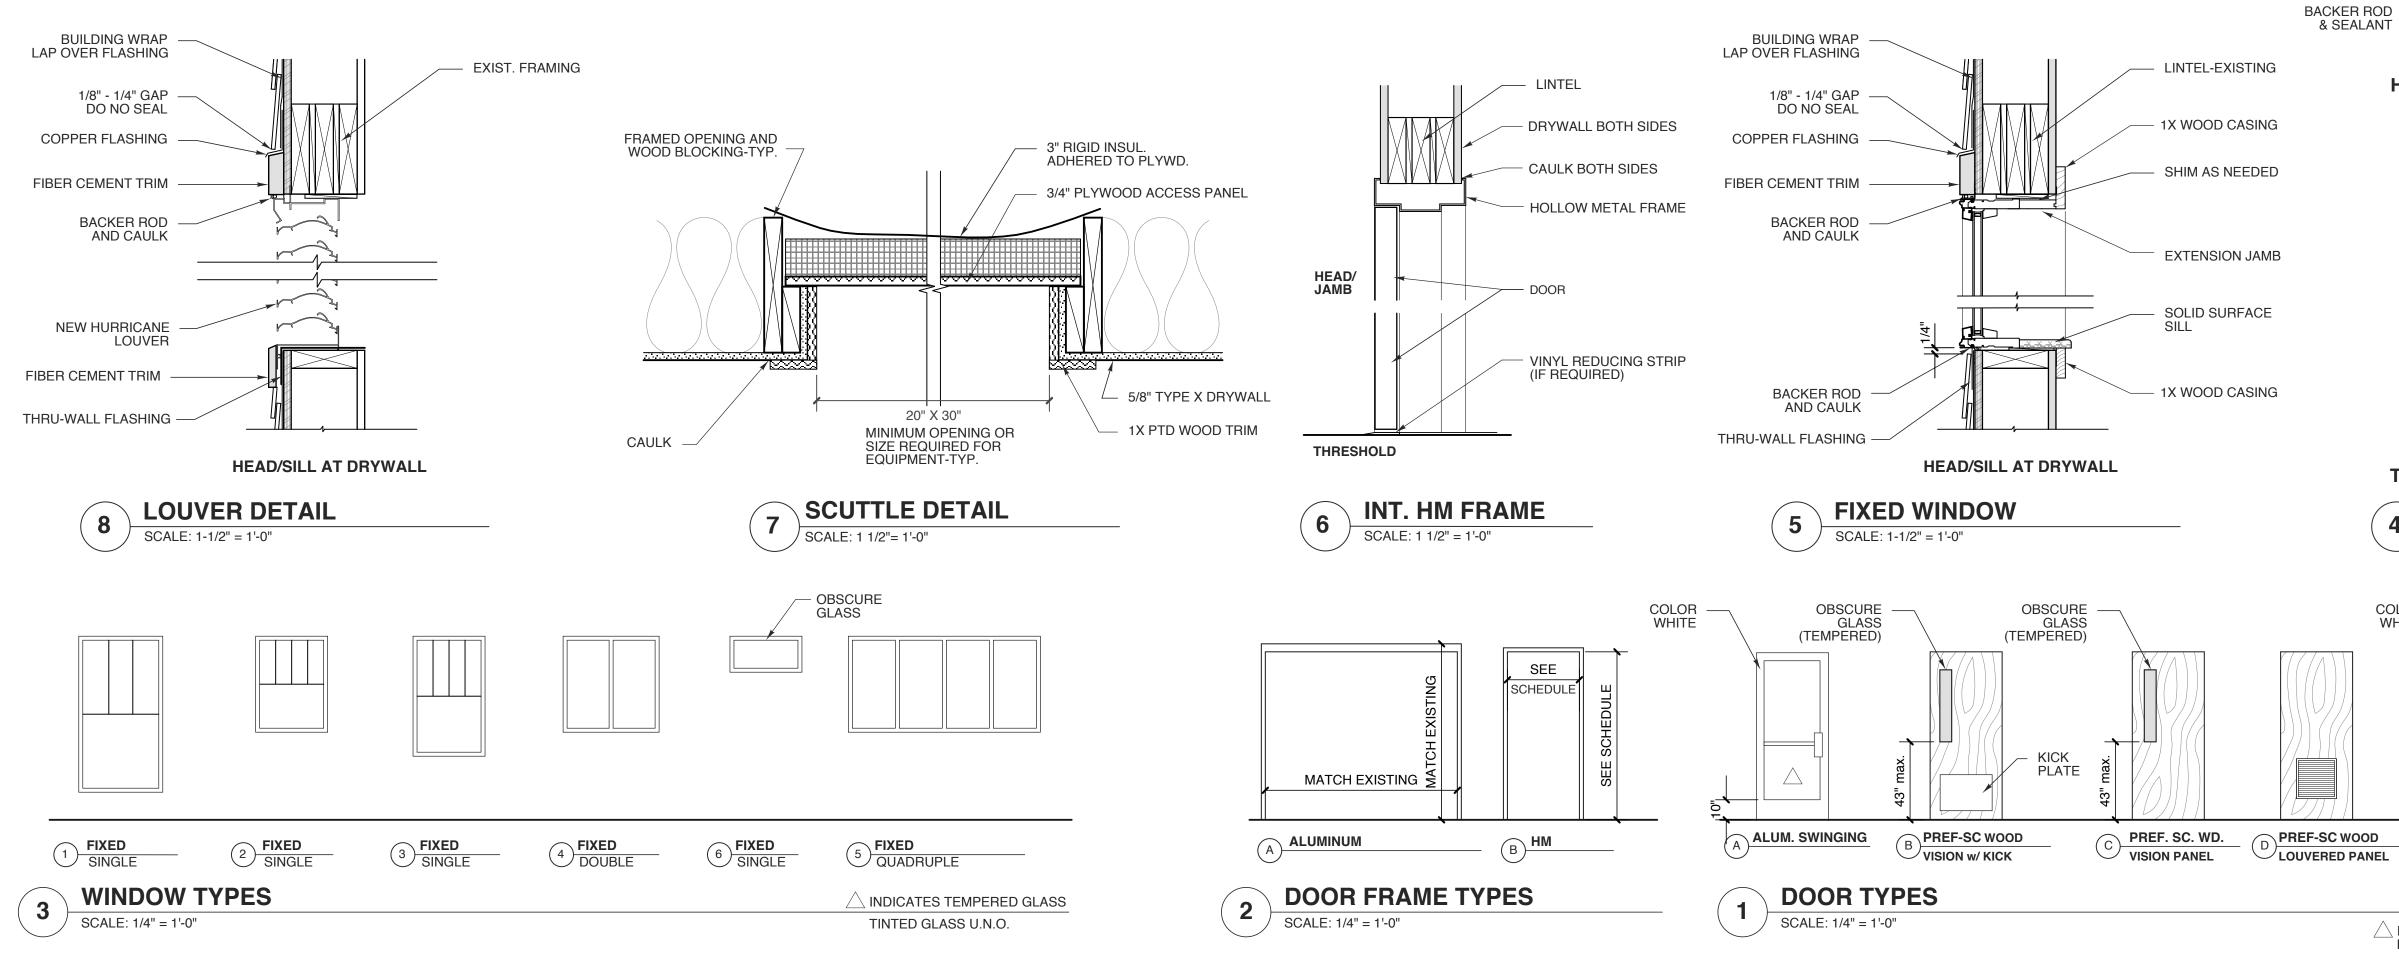PROJECT 1604a DRAWING SCHE	G TITLE	ES/DE	ETAILS
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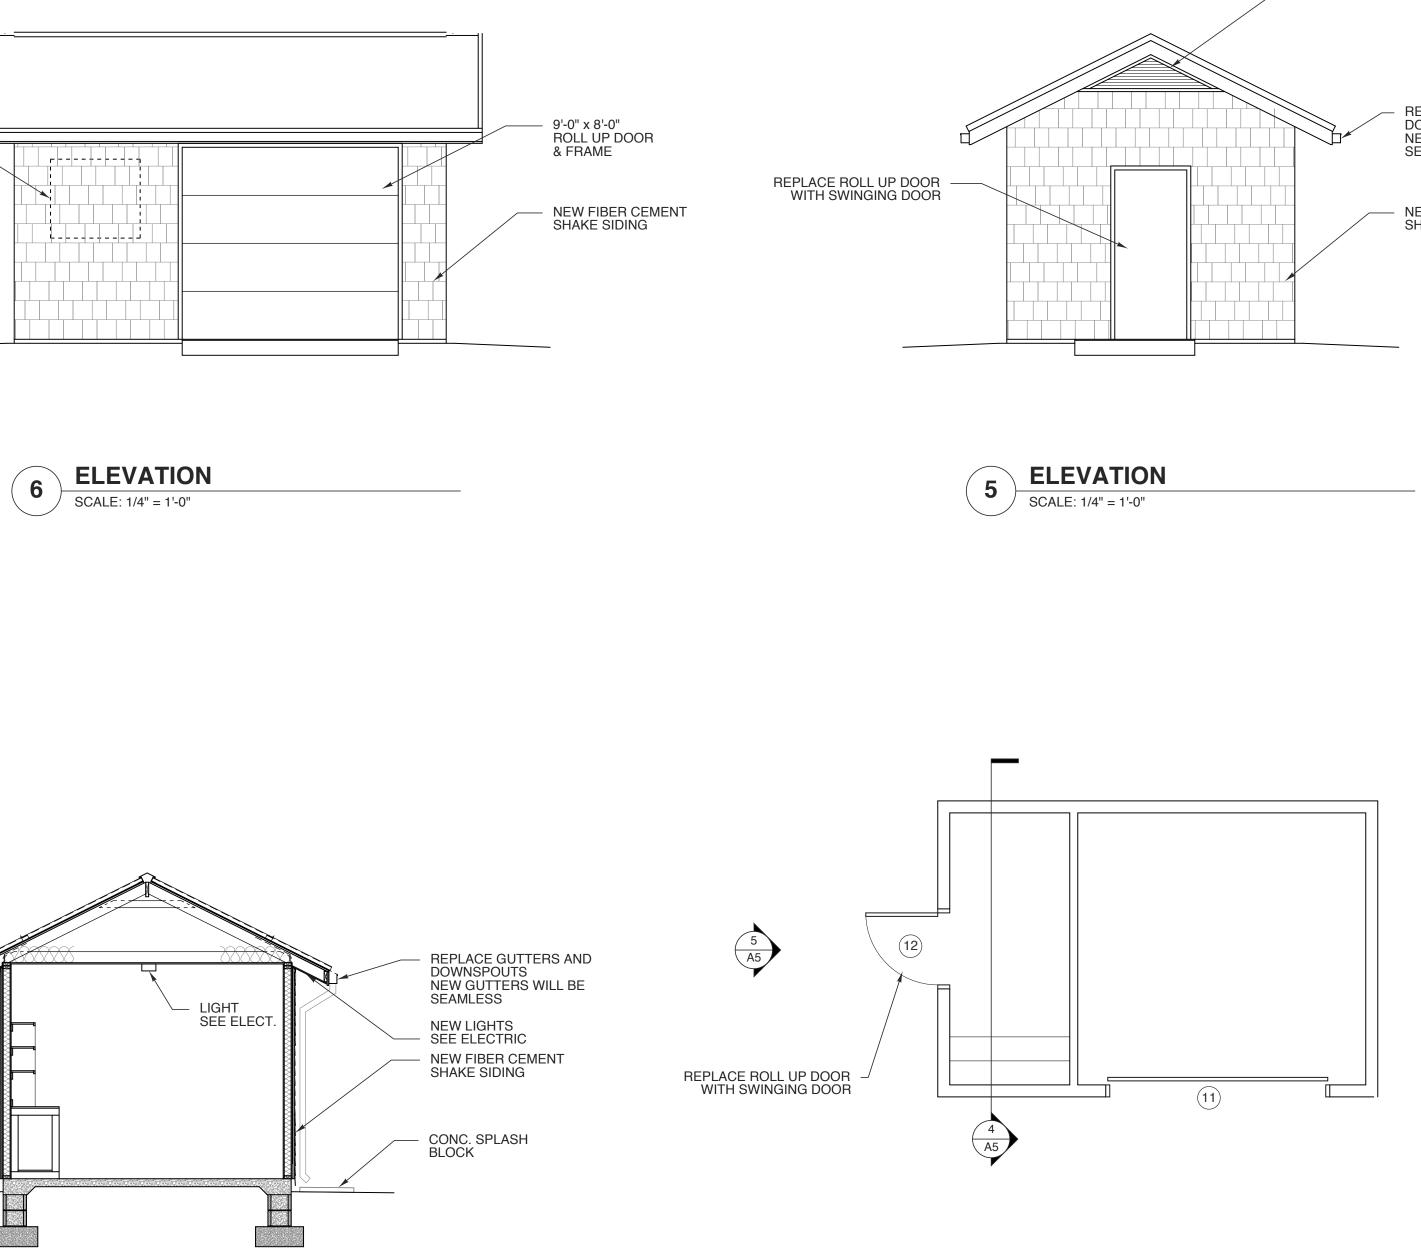
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- (F) FIBERGLASS

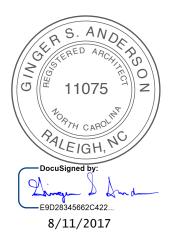DEMO EX. WINDOW INFILL PER DETAIL 3/A1.2

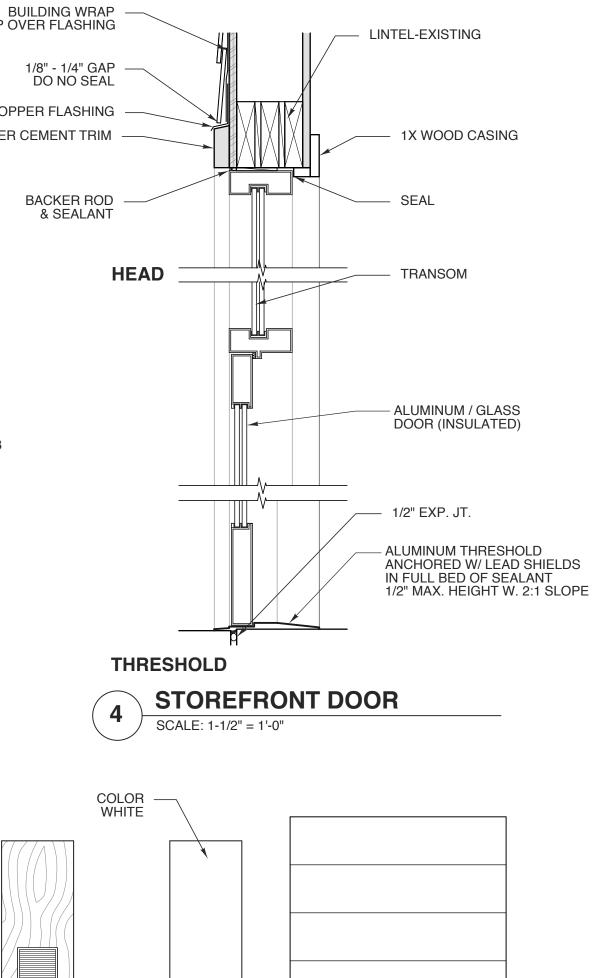

4 BLDG. SECTION SCALE: 1/4" = 1'-0"





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REPLACE GUTTERS AND DOWNSPOUTS NEW GUTTERS WILL BE SEAMLESS

NEW GABLE VENT

NEW FIBER CEMENT SHAKE SIDING

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PROJECT TITLE CARTERET COUNTY REST AREA 3409 ARENDELL STREET MOREHEAD CITY, NORTH CAROLINA

PROJECT NO. **1604a**

DRAWING TITLE STORAGE SHED

SHEET 19 OF 19



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PART 1 – GENERAL 1.1 DESCRIPTION OF THE WORK

- A. Work under this section includes, but is not necessarily limited to, furnishing and installing the following:
- 1. Lighting and power distribution system. 2. Provide lighting fixtures per light fixture schedule with lamps to match.
- 3. Wiring devices, boxes, cover plates, etc. 4. Source of power for all items of equipment.
- 5. Grounding.
- 6. Other requirements and/or systems where shown. B. All work shall be complete and items, equipment, etc., shall be electrically connected for proper and correct
- operation. C. All work under this contract shall be installed in accordance
- with the latest edition of the following codes and standards insofar as they apply:
- 1. The 2014 National Electrical Code.
- 2. The National Electrical Safety Code.
- 3. Underwriter's Laboratories, Inc., Standards and approved listings or other approved 3rd party listing agency. 4. Electrical Testing Labatories standards.
- 5. 2012 North Carolina State Building Code.
- 6. 2012 North Carolina State Energy Code.
-). The Electrical Contractor shall be licensed in the State of North Carolina and have all local licenses required for the work.
- . Local permits are not required. All work must be inspected by the Office of State Construction state electrical inspector and the Engineer of Record. Provide certificate of inspection and approval from the state electrical inspector prior to the final inspection. The electrical contractor is responsible for contacting the state electrical inspector for all required inspections.
- F. All work shall be done by skilled mechanics and shall present a neat, trim, workmanlike condition when complete.
- 1.2 INTENT
- A. The intent of these specifications and the accompanying drawings is to convey as reasonably as possible the requirements for a complete job ready for the building to operate. The Electrical Contractor shall take this into consideration and include in his base bid allowance for contingencies as will allow him to provide minor pieces of equipment and labor not specifically indicated but required for the job to operate properly, at no additional cost to the Owner.
- 1.3 COORDINATION
- A. Coordinate work with other contractors. Notify Architect of apparent conflicts early to expedite construction. If structural damage appears imminent, stop work and notify Architect for a decision before resuming operations.
- B. Locations shown are approximate. The drawings do not give exact details as to elevations and locations of various pipes, fittings, ducts, conduit, etc., and do not show all offsets and other installation details which may be required. Coordinate all locations with architect before any rough-in.
- 1.4 SHOP DRAWINGS
- A. Shop drawings shall be submitted for panels and service equipment, lighting, wiring devices, and cover plates. These may consist of the manufacturer's standard catalog or tear sheets and shall have the exact items being offered clearly identified.
- PART 2 PRODUCTS AND MATERIALS
- 2.1 GENERAL
- A. All material shall be new and shall bear the manufacturer's name, trade name, and be third party acceptable to NCDOI listed and labeled where such standard has been established
- for the particular material. Materials shall be the standard products of manufacturer's regularly engaged in the manufacturer of the required type of equipment and the manufacturer's latest
- approved desian. 1. Boxes installed in concealed locations shall be set flush with
- the finished surfaces. 2. Provide rated boxes in all fire barriers & walls installed per code.

- A. Conductors shall be color coded, sizes #4 and larger may be color taped on the job. Color coding shall comply with 2011 NEC 200.6.
- 208/120V, 3 phase Phase A- Black
- Phase B- Red Chase C- Blue
- Neutral- White Ground- Green
- 480/277V. 3 phase
- Phase A- Brown Phase B- Orange
- Chase C- Yellow
- Neutral— Natural Gray Ground- Green
- B. Conductors shall be manufactured by Dodge, Southwire or approved equal. Conductors shall meet the latest requirements of NEMA and IPCEA and shall be third party acceptable to NCDOI approved.
- C. Conductors shall be spliced and taped as follows:
- 1. Size #10 and #12, use Ideal "Wing Nuts" or T&B "Piggy" connectors. Connectors shall be rated for 150 degrees C for use in recessed lighting fixtures. 2. Size #8 and larger shall be solderless screw and screw-clamping type, smoothly covered and shaped
- with rubber gum type with final cover vinyl plastic electrical type. In lieu of rubber gum and vinyl plastic type, factory fabricated approved preformed insulating covers may be used. All connectors shall be UL approved.
- 3. No split-bolt type connectors may be used.
- D. All branch wire and connections shall be copper and sized per National Electric Code.
- E. All conductors shall be continuous without splice between junction, outlet, device boxes, etc. No splicing will be permitted in panelboard cabinets, safety switches, etc.
- F. All wiring in mechanical spaces shall be plenum rated.
- G. Provide GFI protection within 6'-0'' of any sink.
- H All multi-wire branch circuits shall comply with 2014 NEC, 210.4(B). 2.3 PANELBOARDS, SAFETY SWITCHES
- A. Panelboards shall comply with NEMA Standard PB 1 Latest Edition and as manufactured by Square D or ITE-Siemens. All panel boards must have copper buses.
- B. Safety switches shall be heavy duty type, size and rating as required for lead service. Safety switches shall be fused or unfused as shown and/or as required. Safety switches serving motor loads shall be horsepower rated for load served.
- 2.4 WIRING DEVICES
- A. Wiring devices shall be commercial grade by Bryant, Leviton, Cooper or approved equal. With matching cover. Color by Architect.
- B. Wiring devices installed under a Kitchen Hood shall have stainless steel covers.
- C. Wiring devices installed over counters shall comply with ANSI A117.1.
- 2.7 CONDUIT
- A. PVC conduit will be allowed under slab. Provide rigid turn-ups.
- B. All exposed conduit shall be rigid where exposed to the elements, located
- less than 8'-0'' above grade or where exposed to hazardous conditions. C. EMT conduit, above slab, concealed or exposed above 8'-0'' shall be used through out the project.
- D. Metallic sheathed "MC" cable should not be used for this project, without designer authorization. MC cable is allowed for light whips 6'-0" or less and where concealed with-in existing construction to minimize demolition work. If used, MC cable shall be 1/2" with minimum #12 AWG copper wire and green insulated copper ground.
- PART 3 EXECUTION 3.1 CIRCUIT GROUNDING
- A. All circuits shall contain an insulated, green, copper grounding uctor, sized in accordance with Table 250-122 of the NE Grounding conductors shall be connected to equipment grounding bus in panelboard and securely attached and grounded to the device or enclosure at the other end.

- A. Outlets and switches shall be solidly grounded to equipment grounding system with a green colored insulated conductor. Electrical connections shall be continuous from equipment ground bus in panelboard to the hex nut on the convenience outlet or switch. 3.3 MOTORS
- A. All motors shall be connected to conduit system with short length (minimum length 24" and maximum length 36") of flexible liquidtight conduit.
- 3.4 EQUIPMENT LABELING
- A. Provide permanent penolic plastic name p switches, wiring troughs, etc., for identifice services, etc. Nameplates shall be secure attached to equipment with stainless steel include the name of the equipment and Color Coding-
- Blue surface with white core- 120/208v equipment Black surface with white core- 277/480v equipment Bright red surface with white core- fire alarm systems Dark red surface with white core- security systems Green surface with white core- "emergency" systems Orange surface with white core- telephone systems Brown surface with white core- data systems White surface with black core- paging systems Purple surface with white core- TV systems
- B. All switch plates, receptacle plates and outlet covers shall be labeled
- C. All empty conduit runs shall be identified and indicated where they terminate.
- D. Provide typewritten directory in each panelboard to
- clearly identify each circuit, service, etc.
- 3.5 JUNCTION AND/OR PULL BOXES
- A. Boxes shall be installed where necessary to avoid excessive runs and/or too many bends between outlets. 3.6 PULL WIRE
- A. Leave pull wire in each empty conduit run.
- 3.7 GROUNDING
- A. All grounding shall be in accordance with Article 250 of the NEC. In addition, the following requirements shall be met: 1. Grounding conductors shall be installed as to permit the shortest and most direct path from equipment to ground.
- All connections to grounding conductors shall be accessible. 2. Equipment ground continuity shall be maintained through
- flexible metal condui 3. All wiring devices equipped with grounding connection shall be
- 4. The frame of all lighting fixtures shall be securely grounded to the equipment ground system with grounding conductors.
- 5. All equipment enclosures, and non-current-carrying metallic parts of electrical equipment, raceway systems, etc., shall be
- effectively and adequately bonded to ground. 6. All equipment enclosures, and non-current-carrying metallic parts of electrical equipment, raceway systems, etc., shall be
- effectively and adequately bonded to ground. 7. The reaceway system shall not be relied on for ground continuity A green grounding conductor, properly sized per NEC table 250-122,
- shall be run in all power raceways.

3.8 ELECTRICAL WORK IN CONNECTION WITH OTHER WORK


A. The trade(s) furnishing equipment will provide disconnect switches, motor starters, and make final equipment connections. ELECTRICAL CONTRACTOR will make line side connections to disconnect switches or motor starters.

3.9 CLEAN UP

A. During construction, keep the site clean of debris. Upon completion, and before final inspection, clean up the premises to remove all evidence of work. In addition upon completion of construction leave equipment clean.


3.10 GUARANTEE

A. Guarantee all materials and labor included in the electrical work for a period of one year from date of final acceptance by the Owner. Any part or parts of the work or equipment which prove to be defective during the guarantee period shall be replaced at no additional cost to the Owner.

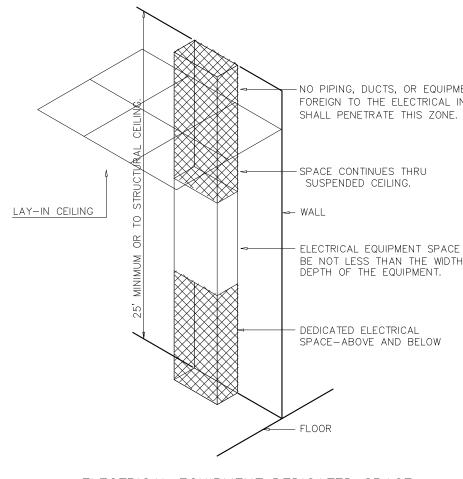

ELECTRICAL EQUIPMENT DEDICATED SPACE PER ARTICLE 110.26.F.1 OF N.E.C.



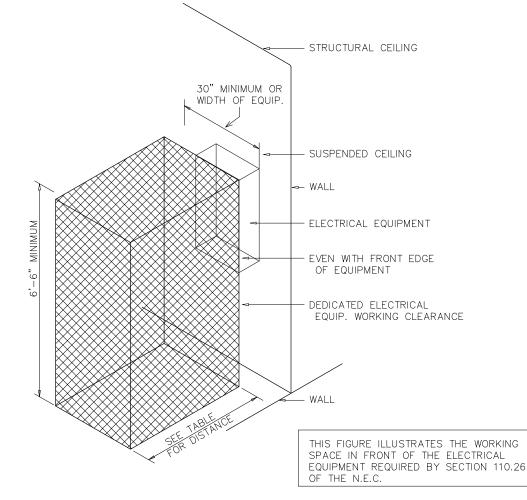



PER ARTICLE 110.26 OF N.E.C.

WORKING CLEARANCES										
VOLTAGE TO			DISTANCE IN	FEET						
GROUND NOMINAL	CONDITION:	1	2	3						
0-150		3	3	3						
151-600		3	3-1/2	4						

1 EXPOSED LIVE PARTS ON ONE SIDE OF THE WORKING SPACE AND NO LIVE OR GROUNDED PARTS ON THE OTHER SIDE OF THE WORKING SPACE, OR EXPOSED LIVE PARTS ON BOTH SIDES OF THE WORKING SPACE THAT ARE EFFECTIVELY GUARDED BY INSULATING MATERIALS. 2 EXPOSED LIVE PARTS ON ONE SIDE OF THE WORKING SPACE AND GROUNDED PARTS ON THE OTHER SIDE OF THE WORKING SPACE. CONCRETE, BRICK OR TILE WALLS SHALL BE CONSIDERED AS GROUNDED. 3 EXPOSED LIVE PARTS ON BOTH SIDES OF THE WORK

3.2 GROUNDING TYPE CONVENIENCE OUTLETS AND SWITCHES

plates for all panelboards, safety
cation of equipment controlled,
ely and permanently
el screws. Nameplates shall
where it is fed from.

with machine printed vinyl labels identifying the circuit(s) within.

solidly grounded to ground system with grounding conductors.

ELECTRICAL SYSTEMS AND EQUIPMENT PRESCRIPTIVE ______ PERFORMANCE_____ ENERGY COST BUDGET__ Provide a standard riser diagram which indicates designated points for check metering Provide a standard panel schedule description which identifies different enduse loads. METHOD OF COMPLIANCE Lighting schedule:X lamp type required in fixture number of lamps in fixture See Liaht ballast type used in fixture Fixture Schedule number of ballasts in fixture total wattage in fixture total interior wattage specified vs. allowed 1355VA / 1481VA Equipment schedules with motors (not used for mechanical systems) NA motor horsepower number of phases NA minimum efficiency NA

DESIGNER STATEMENT I hereby certify that the design of this building complies with the electrical systems, services systems, and equipment requirements of the 2012 North Carolina State Building Code, Energy Edition.

NA

motor type

of poles

- (6) JUNCTION BOX MAY BE SHOWN ON ELECTRICAL PLANS FOR SOME EQUIPMENT IF NO STARTER OR DISCONNECT IS SUPPLIED, A JUNCTION BOX SHALL BE INSTALLED ADJACENT TO EQUIPMENT. THE ELECTRICAL CONTRACTOR SHALL PROVIDE LINE SIDE WIRING TO THF JUNCTION BOX. LOAD SIDE WIRING WILL BE PROVIDED BY MECHANICAL CONTRACTOR OR OTHER TRADES (7) PROJECTS UTILIZING AN MCC. THE STARTER, CB, OR VFD IN THE MCC ARE PROVIDED BY THE ELECTRICAL
 - CONTACTOR. (8) IN ALL CASES THE EQUIPMENT CONTRACTOR SHALL MAKE FINAL CONNECTIONS, START UP, AND TEST EQUIPMENT.

AREA OF

WORK

ELECTRICAL NOTES

OTHER TRADES

CONTRACTOR

BREAKER SIZES.

(1) EQUIPMENT OF TRADES OTHER THAN ELECTRICAL.

(2) CONDUIT & WIRING BY HVAC PLUMBING CONTRACTOR, OR

(3) IF AN ADDITIONAL DISCONNECT IS REQUIRED BY NEC, IT

SHALL BE PROVIDED AND INSTALLED BY THE EQUIPMENT

(4) A COMBINATION STARTER OR VFD MAY BE USED IN LIEU


OF A SEPARATE DISCONNECT SWITCH AND STARTER.

WORK. SEE PANELBOARD SCHEDULES FOR WIRE AND


(5) FEEDER CIRCUIT WIRING AND CONDUIT IN ELECTRICAL

LOCATE ADJACENT TO EQUIPMENT.

- (9) IF THE ROOF TOP EQUIPMENT IS NOT PROVIDED WITH BUILT IN SWITCH, THE ELECTRICAL CONTRACTOR SHALL PROVIDE A DISCONNECT SWITCH.
- 0 in a single prime contract, it is the responsibility of the PRIME CONTACTOR TO COORDINATE BETWEEN THE ELECTRICAL AND OTHERS TRADES

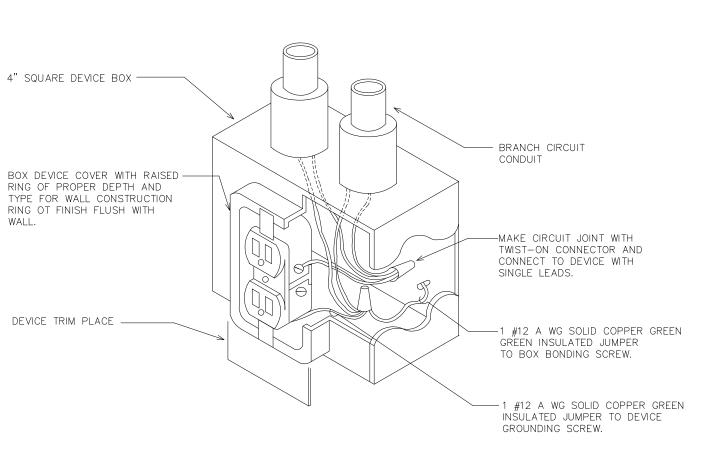

RECEPTACLE GROUNDING DETAIL NOT TO SCALE

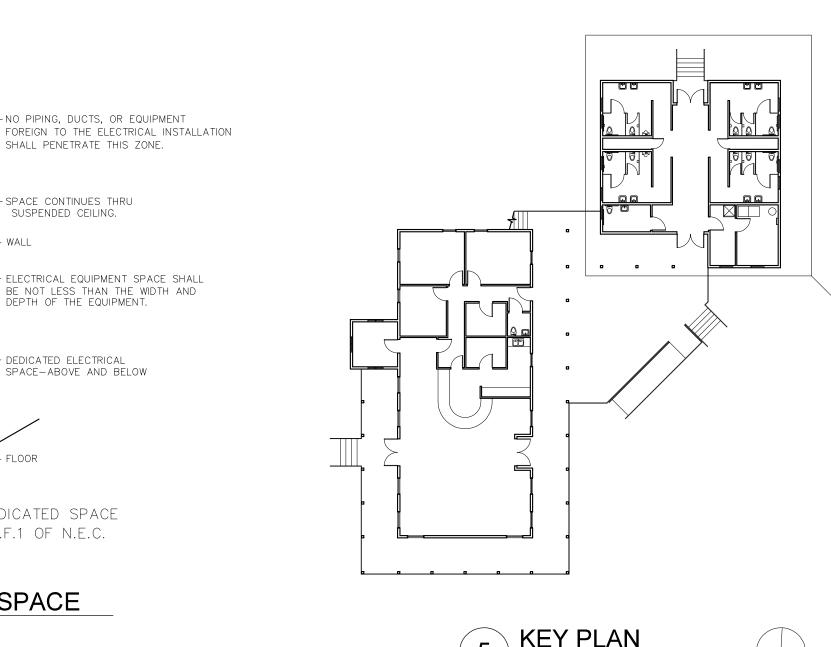


SCALE: NOT TO SCALE

----1 г — — — — -|1 9 I ROOF TOP EQUIPMENT WITH BUILT-IN | ___<u>SWITCH</u>___ _ _ _ _ _ _ 11 _ _ _ _ _ _ _ _ (3 L L __ __ __ __ -



FLECTRICAL LEGEND

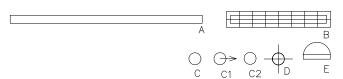

()

WP/GFI

 $\overline{}$

MTP

TC

EXIT

 $\nabla \Box$

PANEL /

ADA

C C1 C2

LIGHT FIXTURE: LETTER DENOTES TYPE OF LIGHT FIXTURE (REFER TO LIGHTING PLAN AND FIXTURE SCHEDULE).

CABINET EXHAUST FAN

DUPLEX RECEPTACLE - 120V; MOUNT 18" TO CENTER AFF UNLESS NOTED OTHERWISE; 'WP' INDICATES WEATHER PROOF, 'GFI' INDICATES GROUND FAULT CURRENT INTERRUPT PROTECTED. 'L' INDICATES LOCKING COVER, PROVIDE KEY.

QUADRAPLEX RECEPTACLE - 120V

LIGHT SWITCH

LIGHT SWITCH WITH INTEGRAL INFRARED MOTION SENSOR FOR AUTOMATIC SHUT-OFF WITH UP TO 2 HOUR ADJUSTABLE DELAY.

PUSH BUTTON OVERRIDE FOR LIGHT CIRCUIT

MOTOR RATED SWITCH

JUNCTION BOX

TELE/DATA OUTLET - PROVIDE JUNCTION BOX AND CONDUIT WITH PULL STRING ABOVE CEILING. PROVIDE WIRING BACK TO SERVICE ENTRY.

MAIN TELEPHONE PANEL- PROVIDE 2'X2' FIRE RESISTANT BACKBOARD. PROVIDE (2) 2" CONDUITS TO TELEPHONE SERVICE RIGHT-OF-WAY. SEE SITE PLAN FOR LOCATION.

TIME CLOCK

SINGLE-POLE HOMERUN TO PANELBOARD

TWO-POLE OR 3-POLE HOMERUN TO PANELBOARD

EMERGENCY LIGHT

EXIT LIGHT

COMBINATION EXIT/EMERGENCY LIGHT

BRANCH CIRCUIT WIRING

---- SWITCH LEG

GROUND CONNECTION

DISTRIBUTION PANELBOARD

DISCONNECTING MEANS AS REQUIRED BY CODE

EXTERIOR PHOTOCELL

ADA DOOR OPERATOR BUTTON



Ben Burke -C93761FB80F34D5. 8/11/2017

STATE ID# 17-17533-01A WBS ELEMENT 51213.031

PROJECT TITLE CARTERET COUNTY rest area 3409 ARENDELL STREET MOREHEAD CITY, NORTH CAROLINA

PROJECT NO. 1604a

DRAWING TITLE ELECTRICAL NOTES, SPECS, DETAILS




PLOT DATE


8/11/17

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ELECTRICAL EQUIPMENT CONNECTION

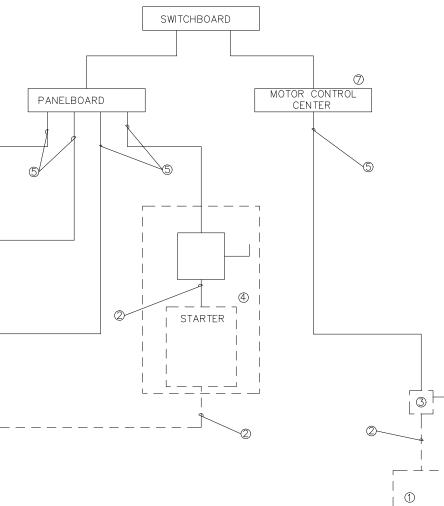


DEMO LIGHTING PLAN SCALE: 1/4" = 1'-0"

MARK	MANUFACTURER	CATALOG NO.	VOLT.		LAMPS TYPE		BALLAS [®] TYPE	IREMARKS					
А	FINELITE	HP-4ID-8'-S-S-3500K-TG-120V-FA-SC-C4	120	-	LED	36	_	SURFACE-MOUNT INDIRECT/DIRECT LUMINAIRE					
В	COLUMBIA	CS4-232-EPU-CSWG4	120	2	Т8	32	EB	48" STANDARD STRIP, WIRE GUARD	**				
С	PRESCOLITE	LF6LED-6LFLED540K	120	-	LED	20	_	6" RECESSED CAN, IC RATED					
C1	PRESCOLITE	LF6LED-6LFLED540K	120	-	LED	20	_	6" RECESSED CAN, IC RATED, WALL WASHER					
C2	PRESCOLITE	LF6LED-6LFLED540K	120	-	LED	20	-	6" RECESSED CAN, IC RATED, WP CASE					
D	PENDANT	CHOSEN BY ARCH. PROVIDED BY EC	120	-	LED	25	_	LED PENDANT FIXTURE (\$250 ALLOWANCE EACH), PROVIDE 3 SPARE FIXTURES					
Е	DUAL-LITE	PGN	120	-	LED	17	_	EXTERIOR NORMAL/EMERGENCY LIGHT FIXTURE- COLOR BY ARCH					
F	PRESCOLITE	LBSQLEDA10L-35K-9-WH	120	-	LED	20	_	7" SURFACE MOUNT SOFFIT LIGHT					
EXIT	MULE	PVT-1-B-R-U-BA-SD	120	-	LED	2	-	EXIT LIGHT WITH BATTERY, CLEAR GLASS, UNIVERSAL SURFACE, SELF DIAGNOSTICS	**				
	MULE	AL-1-R-WW-SD	120	-	LED	4	-	COMBINATION EMERGENCY (TUNGSTEN)/ EXIT (LED) LIGHT	**				
	MULE	ELW-BB-10L3-DG	120	-	LED	10	_	EMERGENCY LIGHT, BATTERY BACKUP, BATTERY DIAGNOSTICS, COLOR BY ARCH	**				

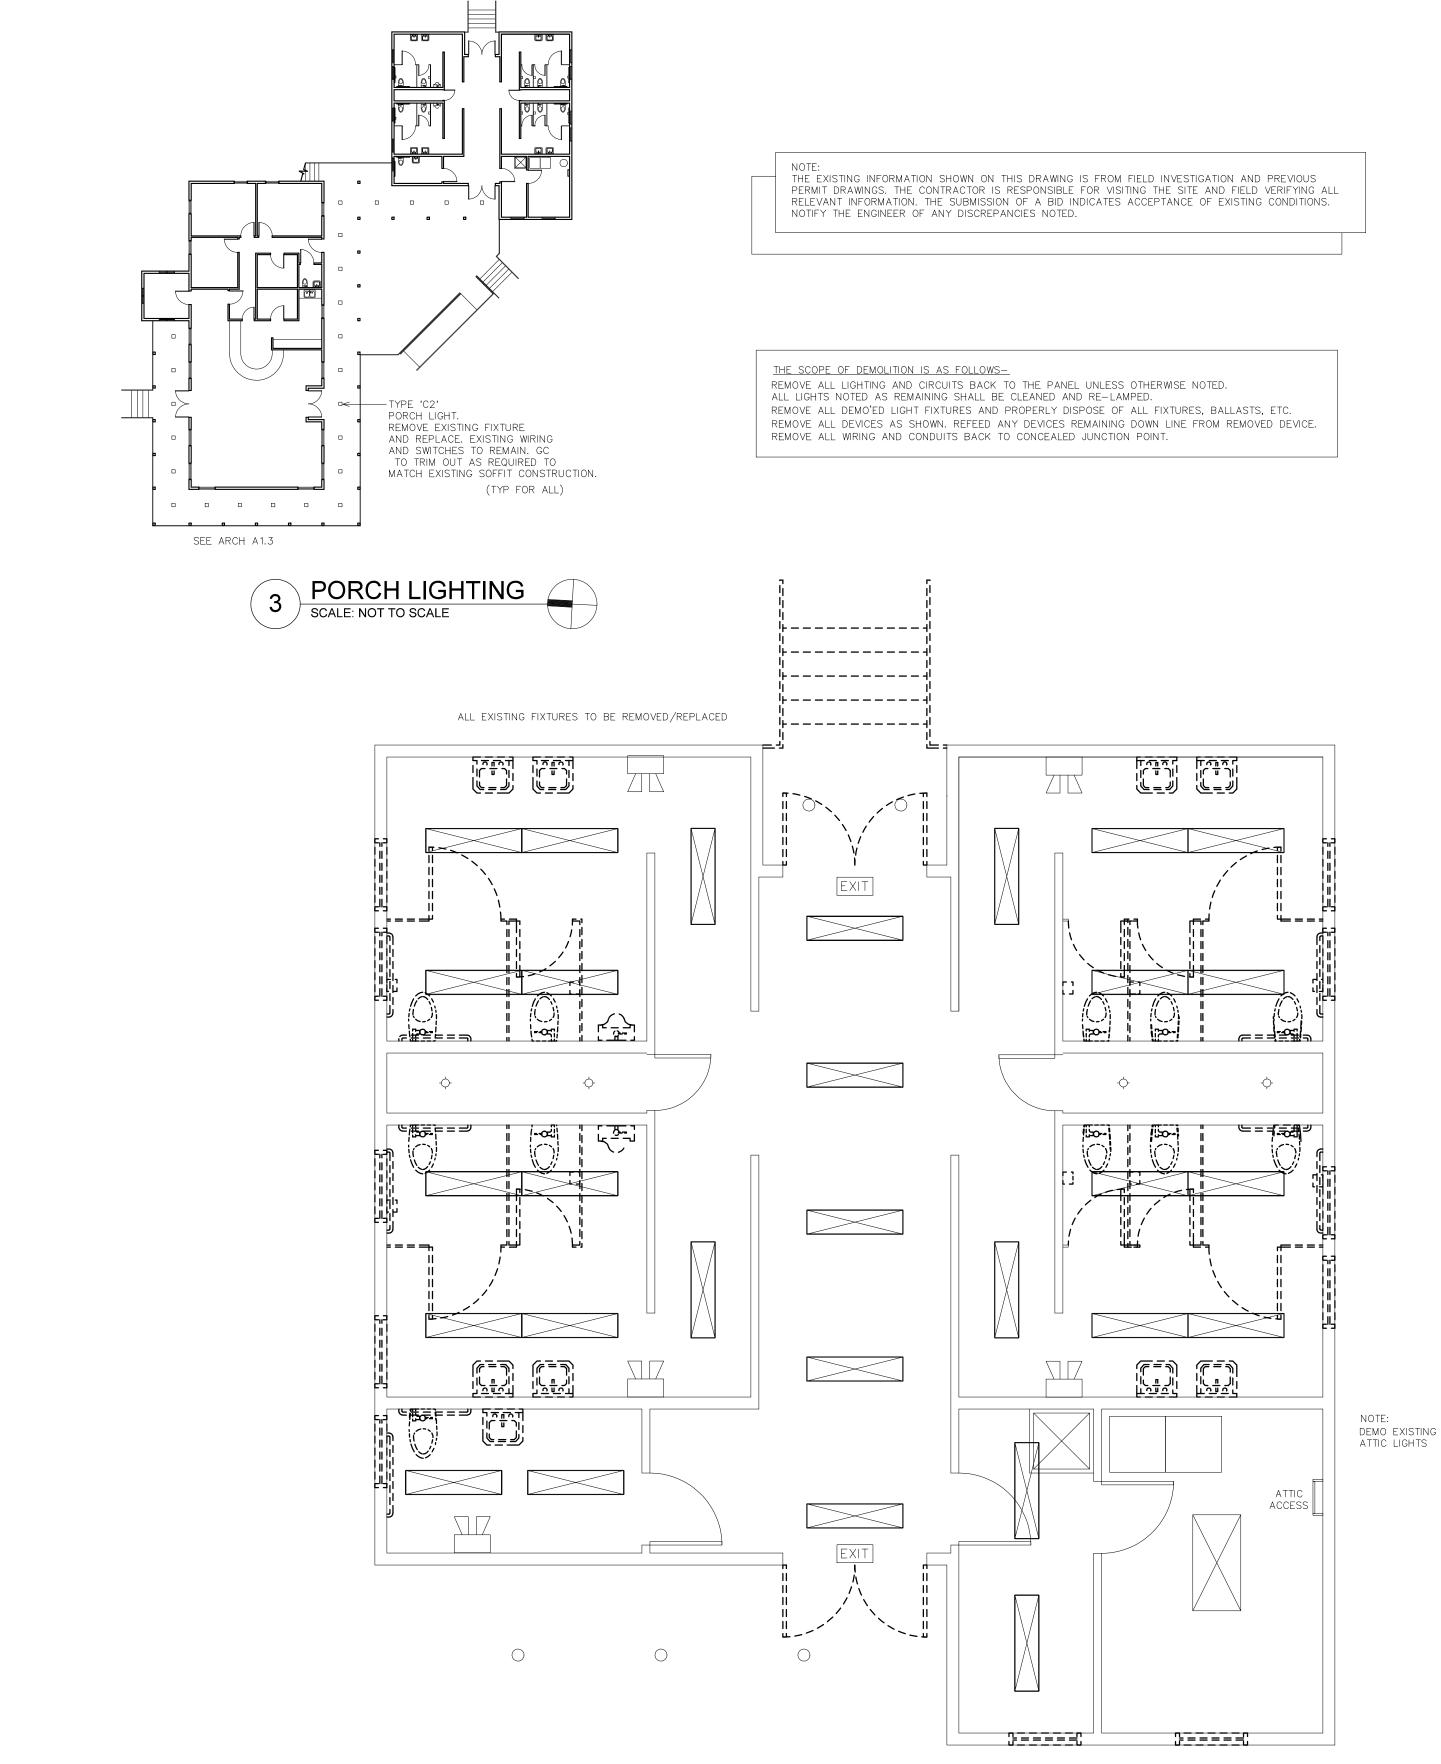MED RAPID START" BALLASTS. CATALOG NUMBERS ARE FOR REFERENCE ONLY, ACTUAL NUMBERS MAY VARY. 'EB' DENOTES ELECTRONIC BALLAST. ** VERIFY FIXTURE HAS INTEGRAL LOCAL DISCONNECTING MEANS PER NEC 410.130 (G) (2011).


THE EMERGENCY LIGHTS AND EXIT SIGNS MUST HAVE INTEGRAL BATTERIES, CHARGERS AND TEST SWITCHES.

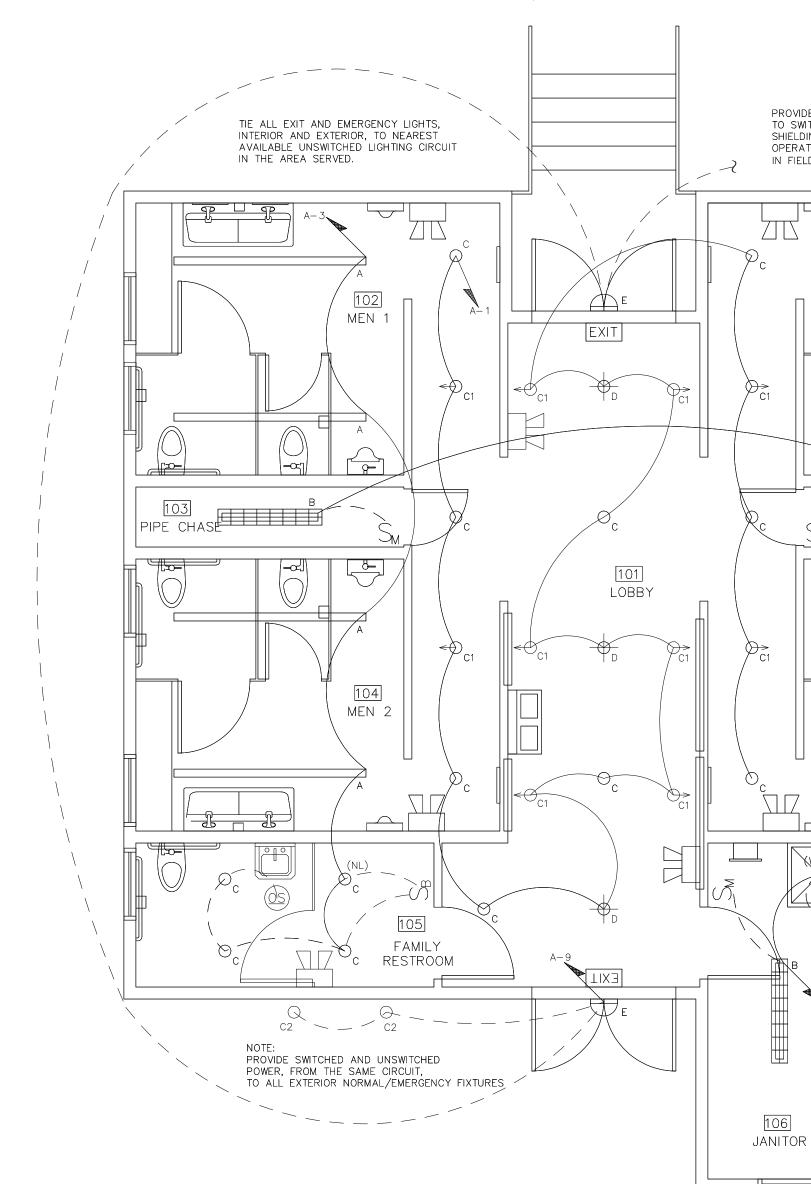





NOTE:

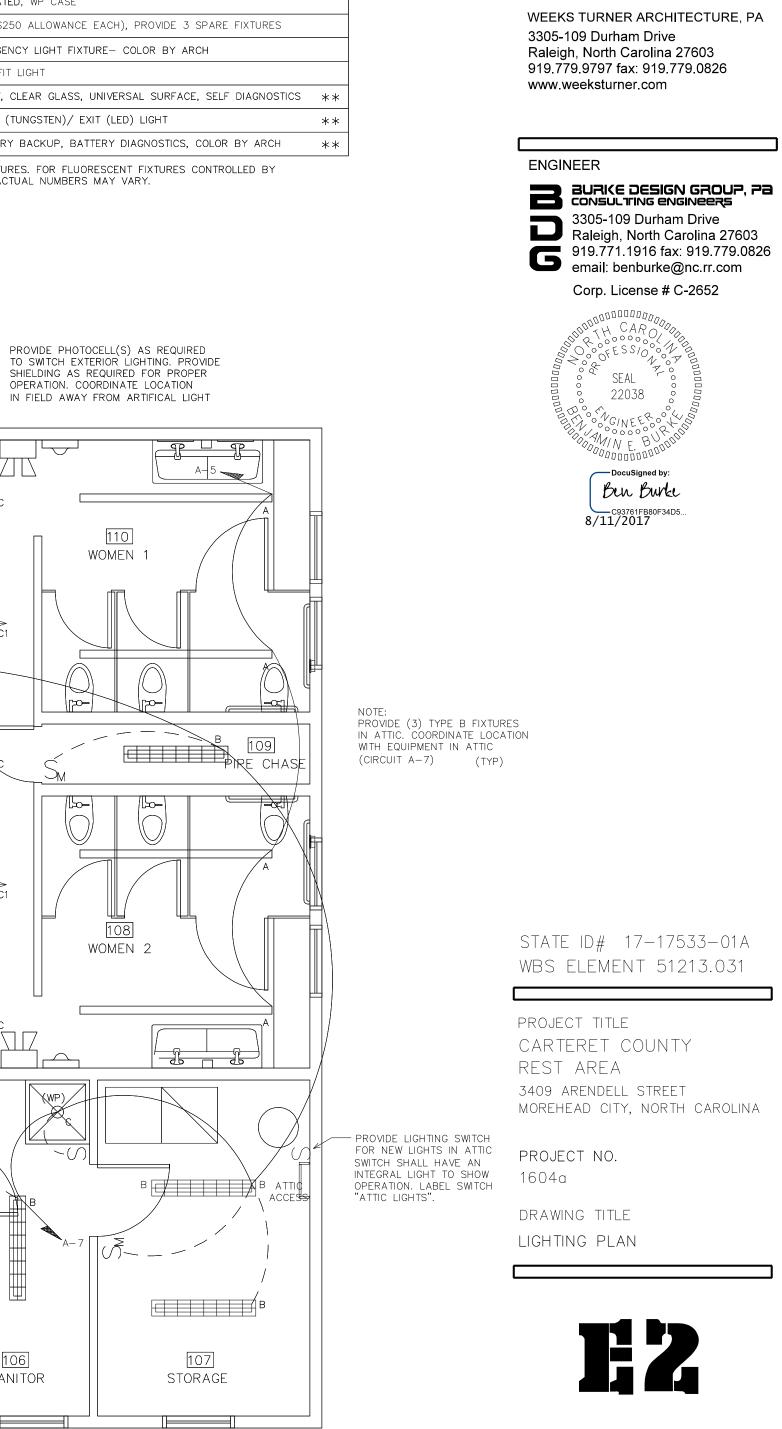

WEEKS

TURNER

ARCHITECTURE

110

108

(WP)/

<u>|-o-</u>]


plot date

8/11/17


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DEMO POWER PLAN 1 SCALE: 1/4" = 1'-0"



2) **KEVIOLU** SCALE: 1/4" = 1'-0"

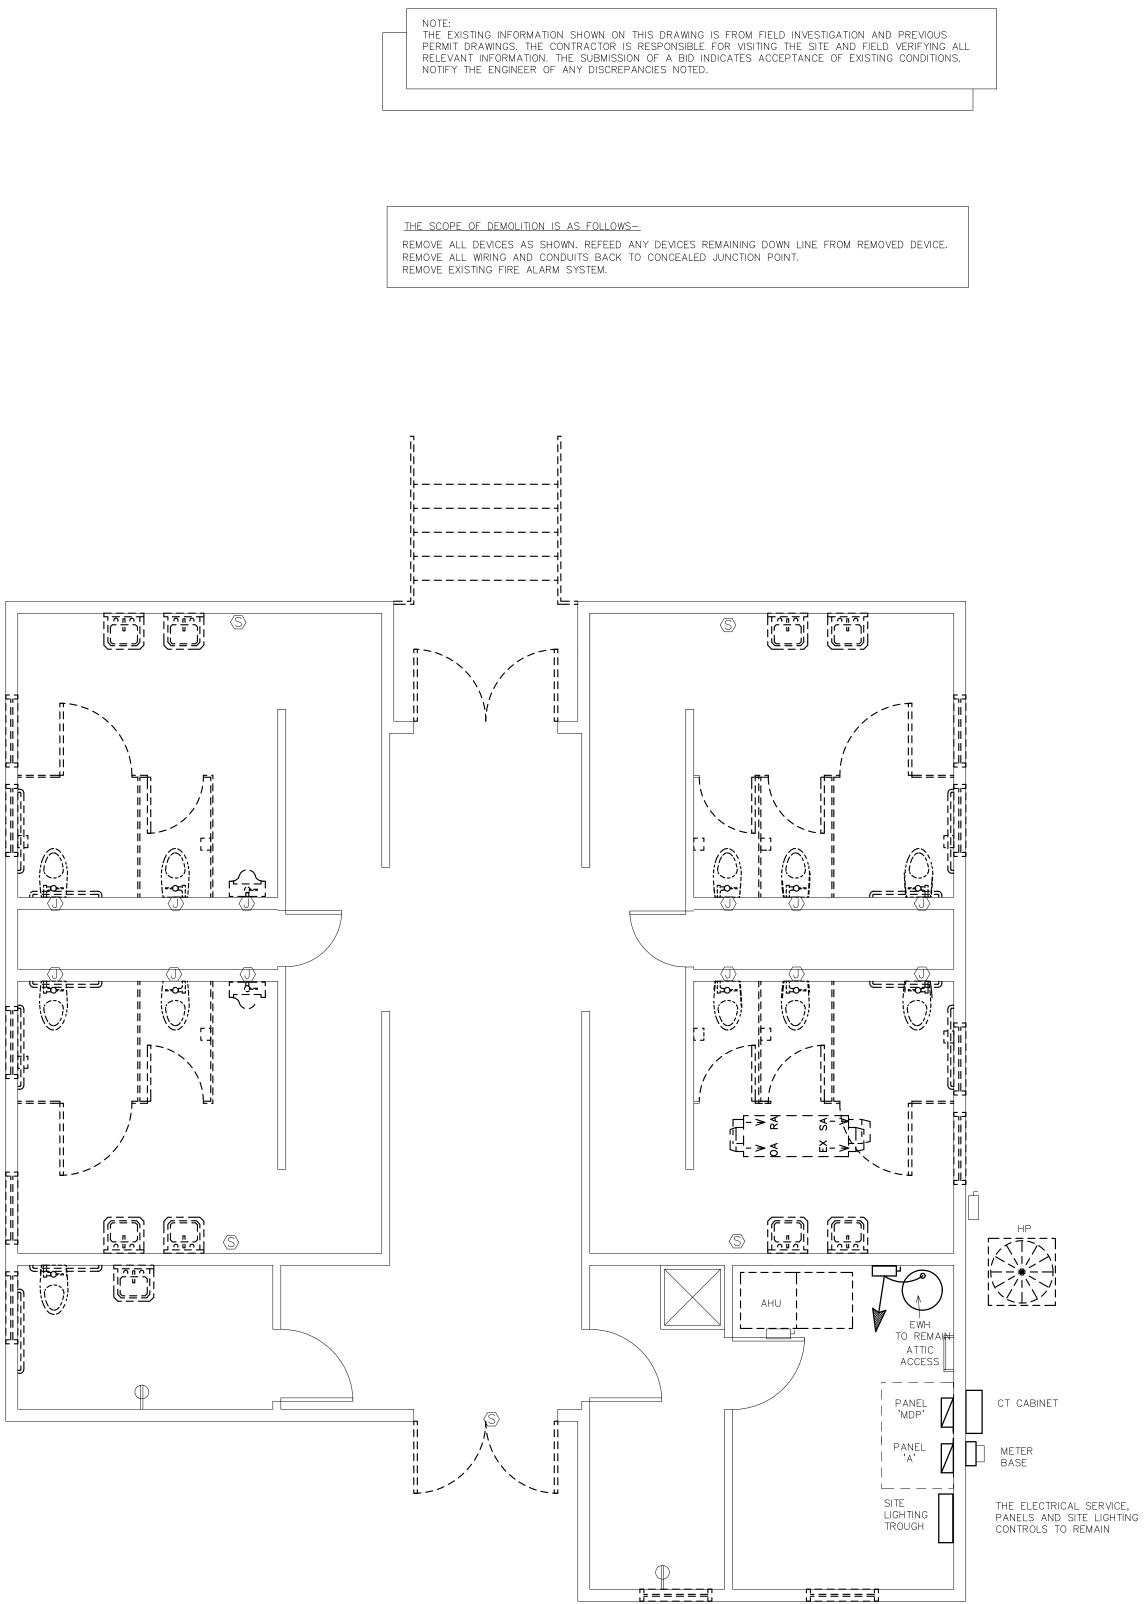plot date


8/11/17

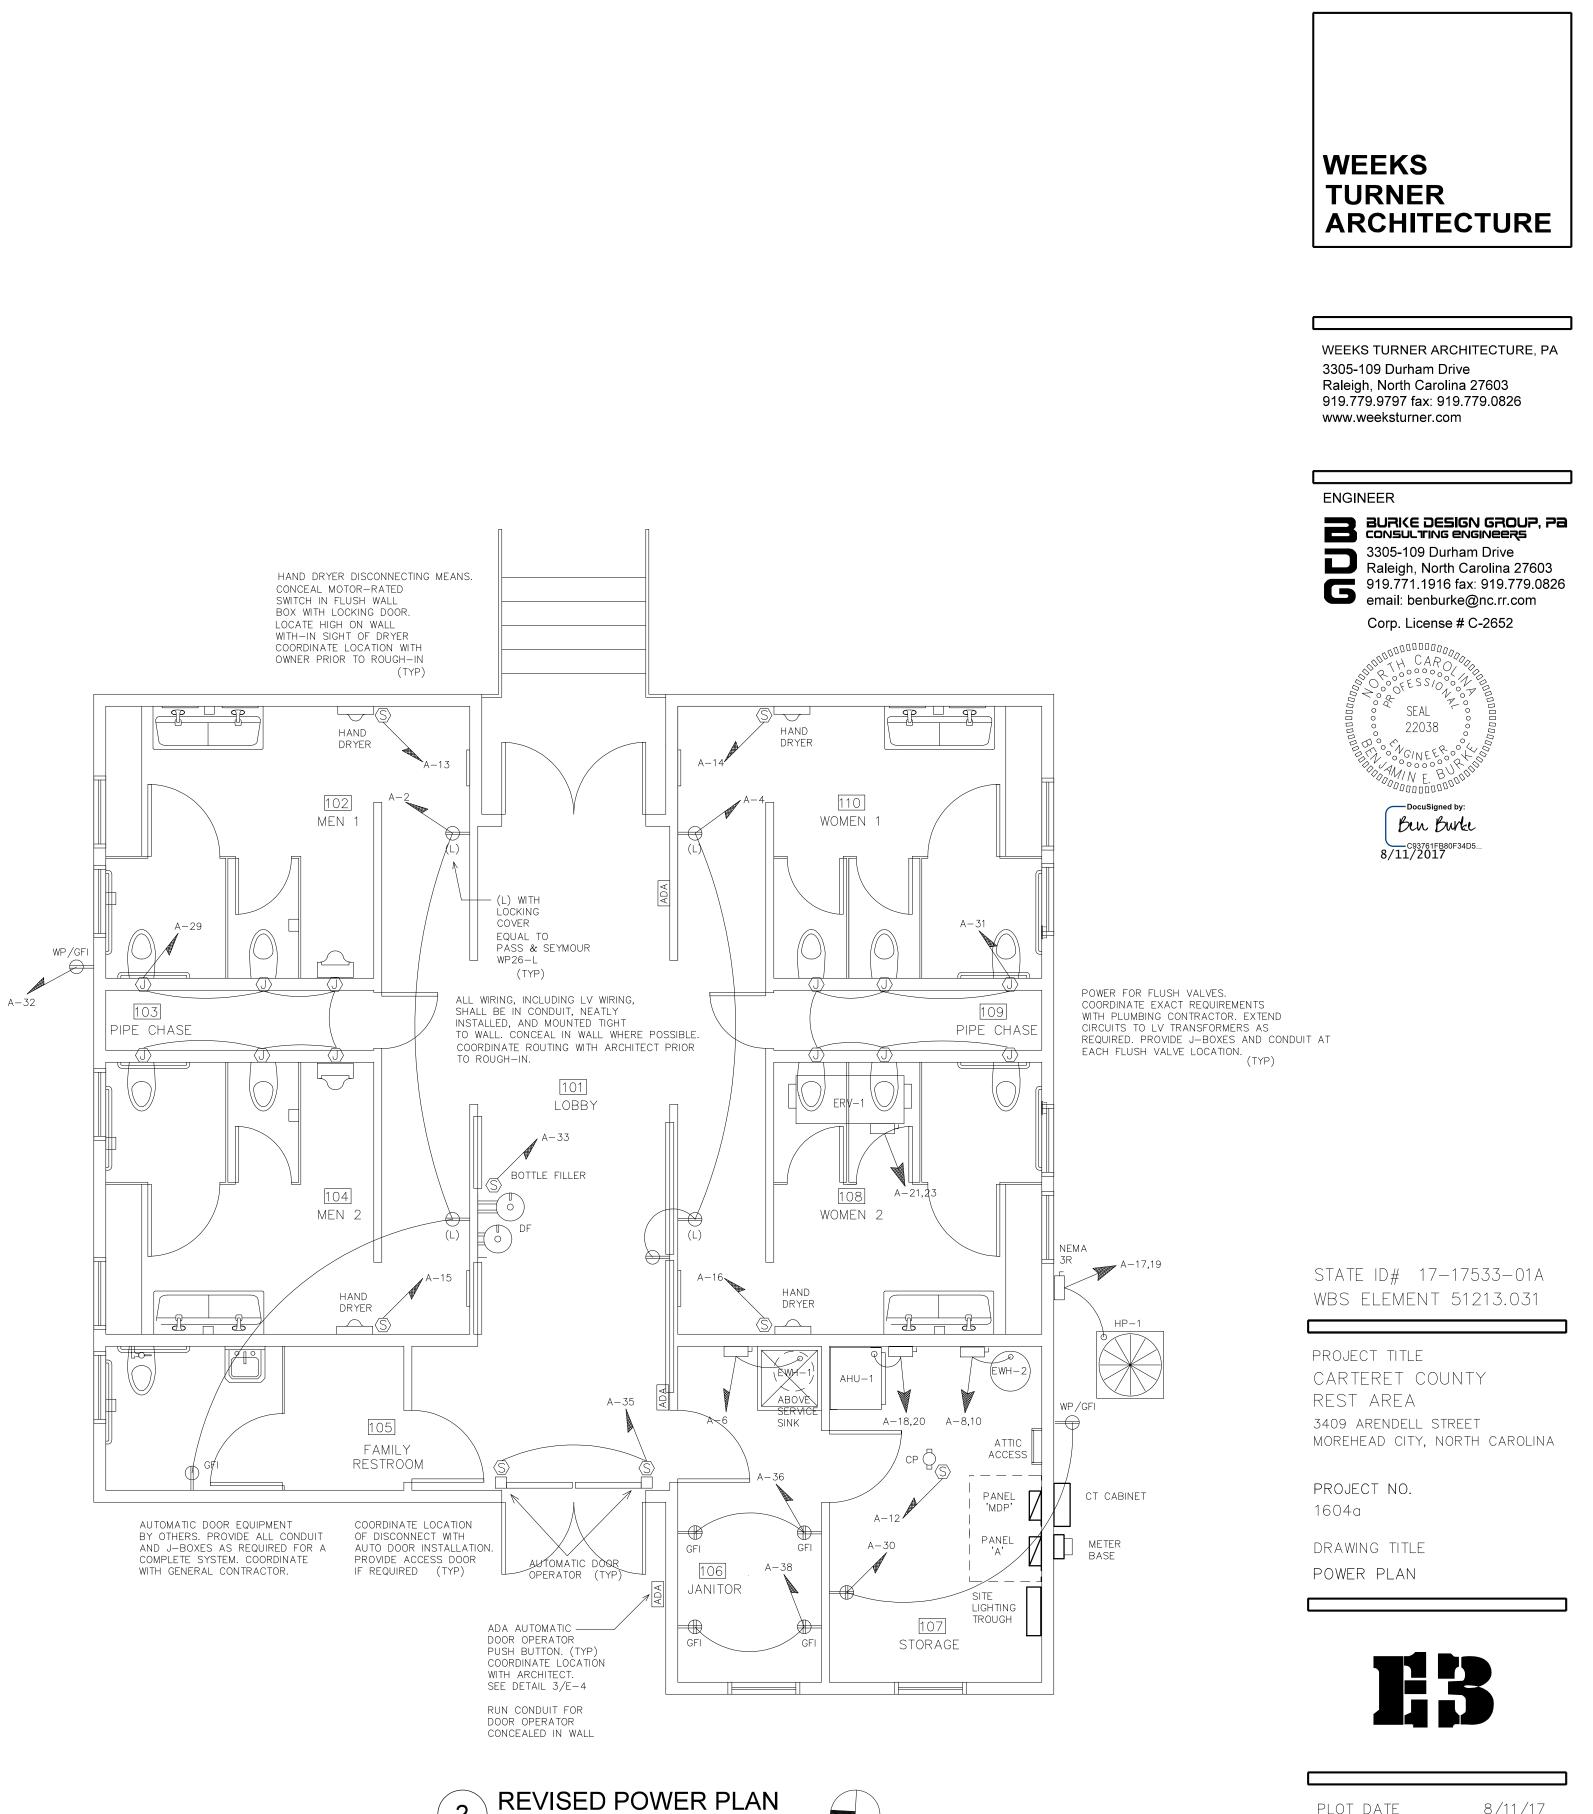
This original sheet is 22" x 34"; other dimensions indicate it has been altered.

1

Carteret Cty E4 EXISTING PANEL- 'A'		WESTINGHO												
EXISTING PANEL - A	TYPE: _	PRL1		MOUNTIN	G: <u>SI</u>	JRFA	CE			EQUIPMENT GROUND BUSXYES DNO				
				MINIMUM	AIC: _VERIFY					SERVICE ENTRY RATED□YES ⊠NO				
LOAD	CKT	WATTS PE	ER PHASE	CKT	CKT NEUTF			CKT	WATTS F	PER PHASE	CKT	LOAD		
SERVICE	BRKR	A	В	NO A		A B		NO	А	B BRKR		SERVICE		
LTS: MEN'S CHASE	20A			1				2			20A	REC: MEN & WOMEN		
LTS: WOMEN'S CHASE	20A			3	\frown		\frown	4			20A	LTS: EMERGENCY & EXIT		
LTS: COORIDOR & DOOR	20A			5			\frown	6			20A	FIRE ALARM PANEL		
LTS: ATTIC	20A			7			\frown	8			30A	WATER HEATER		
TOILET SENSORS	20A			9			\frown	10			JUA			
LTS: PORCH	20A			11	\frown	II	\sim	12			20A	SPARE		
HAND DRYER	20A			13			\sim	14			20A	HAND DRYER		
HAND DRYER	20A			15		L	\frown	16			20A	HAND DRYER		
НР	50A			17			\sim	18			50A	SPARE		
	50/			19	\frown		\sim	20			307			
AHU-#1	80A			21			\frown	22			30A	L-1		
	00/1			23	\frown		\sim	24			307			
SPACE				25			\sim	26			30A	L-2		
SPACE				27	\frown		\frown	28			JUA			
SPARE	20A			29			\sim	30			30A	SPARE		
INLINE FAN	20A			31		I	\frown	32			307			
SPARE	20A			33			\sim	34			20A	AREA LIGHT CONTROL		
SPARE	20A			35	\frown		\sim	36			20A	SPARE		
SPARE	20A			37			\frown	38			20A	SPARE		
SPARE	20A			39			\sim	40			20A	SPARE		
SPACE				41	\cap		\frown	42			20A	SPARE		
NOTES SUB-TO	TALS 'B'					400A	_ [BUS			SUB-	TOTALS 'A'		
					400A LUGS			LUGS			SUB-	TOTALS 'B' TOTAL CONNECTED LOAD		
						400A FEED GRAND TOTAL		D TOTAL						
						/ERIFY	/ (SIZE	——A	A	AMPS	/PHASE		

REVISED PANEL- 'A'		WESTINGH(PHAS	E <u> </u>			UIT BREAKER		
INLVISED I ANLE A	TYPE: 🔟	PRL1		MOUNTIN							ND BUS	, ,	
	1			MINIMUM	AIC: _	verif	Y	1		VIRY R. T	ATED	YES 🕅 NO	
LOAD	CKT		ER PHASE			JTRAL	CKT		PER PHASE	CKT		LOAD	
SERVICE	BRKR	A	B	NO	A	B	NO	A	B	BRKR		SERVICE	
LTS: LOBBY, BATHROOM ENTRYWAYS	20A	455		1		\pm	2	540		20A	REC: RESTR	MOOM	
LTS: MEN'S BATH, FAMILY BATH	20A		224	3		\rightarrow	4		540	20A	REC: RESTR	NOOM	
LTS: WOMEN'S BATH	20A	144		5		$\dashv \cap$	6	1650		20A	EWH-1		
LTS: JANITOR, STORAGE, PIPE CHASE	20A		532	7	\square	\rightarrow	8		2250	- 30A	EWH-2		
LTS: EXTERIOR	20A	74		9	\frown	\rightarrow	10	2250		00/1			
SPARE	20A			11	\frown	$\rightarrow \uparrow$	12		500	20A	CIRC. PUMP		
HAND DRYER				13		$+ \cap$	14	1500		20A	HAND DRYE	R	
HAND DRYER	DRYER 20A		1500	15	$ \frown +$	$\rightarrow \uparrow$	16		1500	20A	HAND DRYE	R	
HP-1	50A	3312		17	\frown	$+ \cap$	18	4188		50A	AHU-1		
	AUC		3312	19	\frown	$\rightarrow \uparrow$	20		4188				
ERV-1	104	2680		21	\frown	$\neg \uparrow$	22	1500		- 30A	L-1		
	40A		2680	23	\frown		24		1500	JUA			
SPACE				25	\frown	\rightarrow	26	1500		- 30A	L-2		
SPACE				27			28		1500	JUA			
RESTROOM SENSORS	20A	600		29	\frown	\rightarrow	30	540		20A	REC: STORA	AGE, EXT	
RESTROOM SENSORS	20A		600	31	\frown		32		180	20A			
BOTTLE FILLER	20A	400		33	\frown	$\neg \uparrow$	34	500		20A	AREA LIGHT	CONTROL	
AUTO DOORS	20A		1000	35	\frown	\rightarrow	36		720	20A	REC: JANITO	OR	
LTS: STORAGE BUILDING	20A	72		37	\frown	$\neg \uparrow$	38	720		20A	REC: JANITO	OR	
LTS: STORAGE BUILDING EXT	20A		97	39	\frown		40			20A	SPARE		
SPACE				41			42			20A	SPARE		
NOTES SUB-TOT	ALS 'B'	9237	9945		4	DOA	BUS	14888	12878	SUB-	TOTALS 'A'		
			-1		<u>400A</u> 400A			9237	9945	SUB-	TOTALS 'B'		
							FEED	24125	22823	GRAN	d total	TOTAL CONNECTED LOAD	
NEW/REVISED CIRCUIT							SIZE	201A	190A	AMPS/PHASE			
NEC ALLOWABLE DEMAND	FACTO	RS		SIFIED	 I O A D	SUM	MARY	1			·		
							EMAND						
(1) DEMAND FACTORS PER NEC 2			LUA	D TYP	_		ACTOR 1	A	В	TOTAL	DIVERSIFIED) LOAD	
(2) LARGEST OF: NEC TABLE 220 CONNECTED LOAD	0.12 OR		GENERAL		;		25%	931	1066		1997		
(3) NEC TABLE 220.56			TRACK LI GENERAL				25% kva@100%	1800	1440		3240		
(4) NEC 220.51			RECEPTAG	CLES			KVA@50%						
(5) NEC 220.43A, 200 VA/LINEAR		MOTORS . EQUIPMEN		RGEST		25% 00%	3960 3544	3960 3544		7920 7088			
6 NON-COINCIDENT LOADS, LAR		WATER H	EATERS		1	25%	4875	2813		7688			
OF THE TWO LOADS IS COUNT		KITCHEN FIX. ELEC			<u> </u>	00% 00%	 3468	3468		 6936			
		SHOW WIN			\sim	25%							
			SIGN				25%	7500			15600		
			MISC		PHAS		00% AL VA)	7500 26078	8100 24391		15600 50469		
							TOTAL	217A	203A		LT AMPS _	= 210A TOTAL	
							AMPS	//	2007		VOLTS	AMPS	

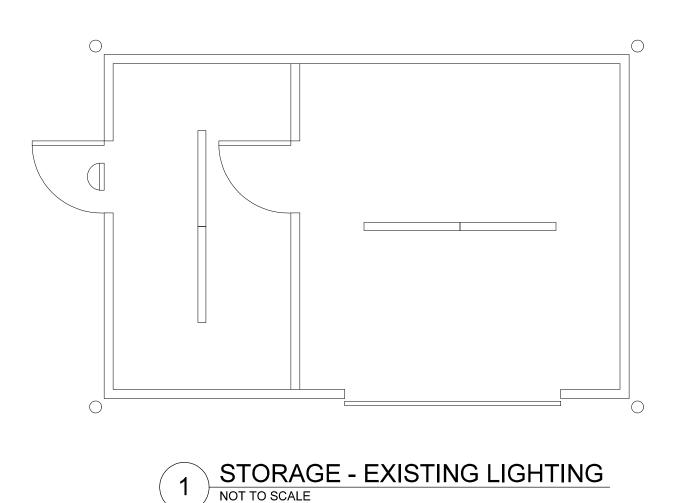

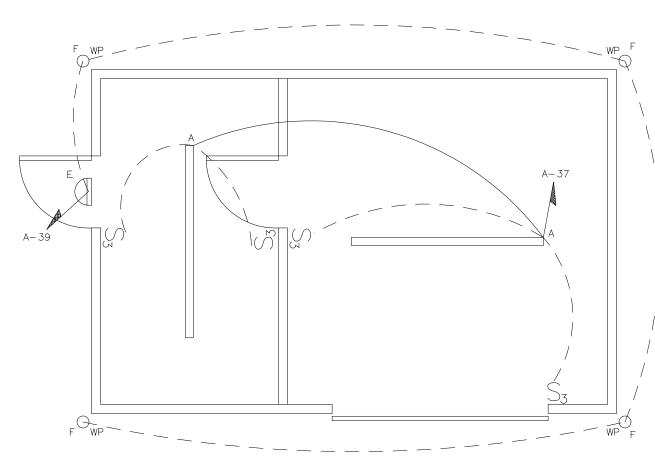

PANEL 'A' SPARE SPACE SPACE NOTES EXISTING/UNCHANGED CIRCUIT

REVISED PANEL- 'MDP'

LOAD

SERVICE

NEW/REVISED CIRCUIT

CONNECTED LOAD

(3) NEC TABLE 220.56

(4) NEC 220.51

NEC ALLOWABLE DEMAND FACTORS

(1) DEMAND FACTORS PER NEC 220

5) NEC 220.43A, 200 VA/LINEAR FT 6 NON-COINCIDENT LOADS, LARGEST OF THE TWO LOADS IS COUNTED

Carteret Cty E4

2 LARGEST OF: NEC TABLE 220.12 OR

TYPE: PRL4

BRKR A

SUB-TOTALS 'B' 24125 22823

22823

400A 24125 I

100A -

Carteret Cty E4		MAKE:	WESTINGHO	USE	RATING:_1	20/	240	_ 1	PHASE	E <u> </u>	<u>600A</u> main circuit breaker				
EXISTING PAN	IEL- MDP	TYPE: _f	PRL4		MOUNTING: <u>SURFACE</u>						EQUIPMENT GROUND BUSXYES 🗆 NO				
					MINIMUM	IMUM AIC: <u>verify</u>					SERVICE ENTRY RATEDXYES □NO				
LOAD		CKT				NEUTRAL		CKT	WATTS F	PER PHASE	CKT		LOAD		
SERVICE		BRKR A B		NO	ļ	A E	}	NO	А	В	BRKR		SERVICE		
PANEL 'A'		400A			1	\sim			2			100A	PANEL 'C'		
		400A			3	\sim			4						
SPARE		1004			5	2			6				SPACE		
		100A			7	\sim			8				SPACE		
SPACE					9	$\overline{}$			10				SPACE		
SPACE					11	\sim		$\overline{\mathbf{v}}$	12				SPACE		
NOTES	SUB-TO1	rals 'B'				_	600A		BUS			SUB-	TOTALS 'A'		
	-						600A		_UGS			SUB-	totals 'B'	TOTAL CONNECTED LOAD	
						_	600A		FEED			GRANE) TOTAL	TOTAL CONNECTED LUAD	
							/ERIF`	<u>ŕ</u> !	SIZE	A	A	AMPS,	/PHASE		
			-												

MAKE: <u>WESTINGHOUSE</u> RATING: <u>120/240</u> 1 PHASE <u>3</u> WRE <u>600A</u> MAIN CIRCUIT BREAKER

B NO A B NO A B

DEMAND

125%

 GENERAL USE
 21000/40100%
 1800
 1440
 3240

 RECEPTACLES
 >10KVA@50%
 --- --- ---

 MOTORS AND
 LARGEST
 125%
 3960
 3960
 7920

 EQUIPMENT
 ALL OTHERS
 100%
 3544
 3544
 7088

 WATER HEATERS
 125%
 4875
 2813
 7688

 KITCHEN EQUIPMENT
 3
 100%
 --- ---

 FIX. ELEC. SPACE HEAT.
 4
 100%
 3468
 3468
 6936

 SHOW WINDOW LIGHTS
 5
 125%
 --- --- ---

 SIGN
 125%
 --- --- --- ---

125% ---

PHASE (TOTAL VA) 36078 34391

100%

10000

EQUIPMENT GROUND BUS _____XYES 🗆 NO

SERVICE ENTRY RATED _____XYES □NO

- 100A PANEL 'C'

SPACE

SPACE

SPACE

SPACE

1997

35600

70469

TOTAL 301A 287A <u>VOLT AMPS</u> = 294A TOTAL AMPS

BRKR

600A LUGS 24125 22823 SUB-TOTALS 'B' TOTAL CONNECTED LOAD

FACTOR A B TOTAL DIVERSIFIED LOAD

10000

600A BUS 10000 10000 SUB-TOTALS 'A'

verify SIZE 284A 274A AMPS/PHASE

125% 931 1066

≤10KVA@100% 1800 1440 3240

17500 18100

LOAD

SERVICE

MOUNTING: <u>SURFACE</u>

MINIMUM AIC: <u>verify</u>

CKT WATTS PER PHASE CKT NEUTRAL CKT WATTS PER PHASE CKT


DIVERSIFIED LOAD SUMMARY

load type

GENERAL LIGHTING


TRACK LIGHTING

GENERAL USE

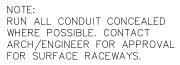



(3)

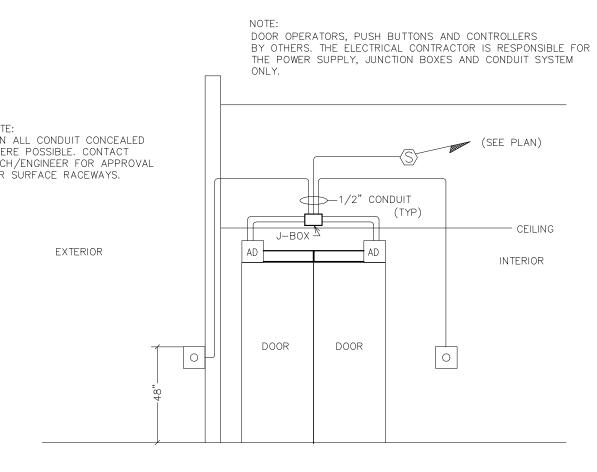

EQUIF	MEN	IT V	VIRIN	G	SCHEDULE
EQUIPMENT	МСА	MOCP	VOLTS	PH	WIRE SIZE
EWH-1	(1650W)	20A	120V	1	2-#12, 1-#12 GND IN 1/2" CONDUIT
EWH-2	(4500W)	30A	240V	1	3-#8, 1-#10 GND IN 3/4" CONDUIT
AHU-1	48.5A	50A	240V	1	3-#6, 1-#10 GND IN 1" CONDUIT
HP-1	34.2A	50A	240V	1	3-#8, 1-#10 GND IN 3/4" CONDUIT
ERV-1	27.9A	40A	240V	1	3-#8, 1-#10 GND IN 3/4" CONDUIT

NOTE THE ELECTRICAL CONTRACTOR SHALL VERIFY ALL EQUIPMENT ELECTRICAL REQUIREMENTS PRIOR TO ROUGH-IN AND RELEASING GEAR. ADJUST BREAKER, WIRE SIZES, ETC. AS REQUIRED.

> REST AREA BUILDING SERVICE ENTRY RATED PANEL PANEL 'MDP' METER BASE 'A' 600 AMP 2 100 AMP 120/240V 120/240V 1 PHASE SITE LIGHTING TROUGH CRAWL SPACE SER VICE GROUND SERVICE CONDUCTORS BY -LOCAL POWER COMPANY. COORDINATE ALL NEW LOADS PRIOR TO START OF WORK NOTE: THE ELECTRICAL SERVICE IS EXISTING AND SHOWN FOR REFERENCE ONLY. NO NEW WORK IS REQUIRED.



STORAGE - REVISED LIGHTING

NOT TO SCALE

2

THE CONTRACTOR SHALL COORDINATE ALL WORK WITH THE GENERAL CONTRACTOR AND DOOR INSTALLER PRIOR TO ROUGH-IN. PROVIDE ALL CONDUIT, JUNCTION BOXES, ETC AS REQUIRED FOR A COMPLETE INSTALLATION.

ADA DOOR CONTROL DETAIL / SCALE: NOT TO SCALE






8/11/2017

RISER WIRING SCHEDULE

- (1) 600A: (2 PAIR) 3-#350 MCM IN (2) 2 1/2" CONDUIT(S)
- (2) 100A: 3-#3, 1-#8 CU GND, IN 1 1/4" CONDUIT
- 3 #3 cu gnd to building steel, foundation steel and metallic water main and #6 cu gnd to 10' x 5/8" driven ground rod
- UNLESS OTHERWISE NOTED ALL OTHER CIRCUITS ARE 20A, 120VOLT. PROVIDE 2-#12, 1-#12 CU GND IN 1/2" CONDUIT. SEE EQUIPMENT SCHEDULES FOR ADDITIONAL WIRE SIZES.

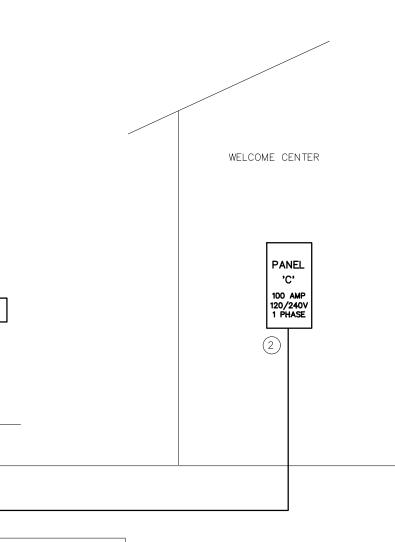

STATE ID# 17-17533-01A WBS ELEMENT 51213.031

PROJECT TITLE CARTERET COUNTY REST AREA 3409 ARENDELL STREET MOREHEAD CITY, NORTH CAROLINA

PROJECT NO. 1604a

drawing title PANELS & RISER



plot date

8/11/17

This original sheet is 22" \times 34"; other dimensions indicate it has been altered.

A	IR DISTR	BUTION	SCHEE	DULE			
MARK	* MANUFACTURER	MODEL NO.	SIZE	FACE SIZE	MATERIAL	SERVICE	NOTES
A	CARNES	SASM-40 W/ ROUND NECK OPTION	6" DIA	-	ALUMINUM	SUPPLY	COLOR BY ARCHITECT GYP CEILING MOUNT
В	CARNES	SASM-40 W/ ROUND NECK OPTION	8" DIA	-	ALUMINUM	SUPPLY	COLOR BY ARCHITECT GYP CEILING MOUNT
с	CARNES	SASM-40 W/ ROUND NECK OPTION	10" DIA	-	ALUMINUM	SUPPLY	COLOR BY ARCHITECT GYP CEILING MOUNT
RA	CARNES	RAJBH	14"X 14"	16" X 16"	ALUMINUM	RETURN	COLOR BY ARCHITECT GYP CEILING MOUNT
RB	CARNES	RAJBH	14"X 6"	16" X 8"	ALUMINUM	RETURN	COLOR BY ARCHITECT DUCT MOUNT
EA	CARNES	RATAF	12" X 12" 10" ROUND NECK 米 米	14" X 14"	ALUMINUM	EXHAUST	COLOR BY ARCHITECT GYP CEILING MOUNT
EB	CARNES	RATAF	10" X 10" 8" ROUND NECK	12" X 12"	ALUMINUM	EXHAUST	COLOR BY ARCHITECT GYP CEILING MOUNT

COORDINATE BORDER TYPE WITH THE CEILING/WALL TYPE. SEE ARCH SHEETS

PROVIDE DUCT TRANSITIONS AS REQUIRED.

 \star or approved equal by tuttle & bailey, or metalaire

 $\star\star$ PROVIDE SQUARE TO ROUND DUCT TRANSITION ON TOP OF GRILLE. PROVIDE INSULATION PACKAGE FOR TOP OF ALL DIFFUSERS AND GRILLES

HVAC E	QUIPMENT SCHEDULE
HVAC SYSTEM #1	
AHU #1 DIRECT EXPANSION FAN COIL UNIT	CARRIER MODEL #FX4DNB061, 4 WAY, MULTIPOISE FAN COIL UNIT. 8 KW HEATER. NOMINAL CAPACITY = 60,000 BTUH. 1800 CFM NOMINAL. PROVIDE HARD SHUT-OFF TXV VALVE. 5 TON NOMINAL. PROVIDE PROGRAMMABLE THERMOSTAT AND FILTER RACK WITH HINGED DOOR. 3/4HP, 6.0A MOTOR FLA, 28.9A HEAT FLA, 240V, 1 PH, 48.5A MCA, 50A MOCP AHU & HEAT.
HP #1 OUTDOOR HEAT PUMP UNIT	CARRIER MODEL #25HCC560A0030, 5 TON OUTDOOR HEAT PUMP UNIT, 15 SEER, PROVIDE CYCLE * PROTECTOR, LOW PRESSURE SWITCH, CRANKCASE HEATER, 240 VOLT, 1 PHASE. COMP 26.4A RLA, FAN 1.2A FLA, OUTDOOR HEAT PUMP 34.2A MCA, 50A MOCP.

* OR APPROVED EQUAL

NOTE: 1. AHU HEATER KW RATINGS ARE AT 240 VOLTS.

2. PROVIDE OUTDOOR TSTAT TO PREVENT ELECTRIC HEAT OPERATION WHEN HEAT PUMP CAN MEET THE HEATING LOAD

3. ERV-1 SHALL RUN AT ALL TIMES WHEN AIR HANDLING UNIT IS RUNNING. AHU-1 FAN SHALL RUN AT ALL TIMES.

ENE	ERGY RECOV	/ERY	UNIT	SCHEDU	JLE												
											THERMAL PERFOR	RMANCE					
				FAN	s / Moto	रऽ				DESIGN CO	ONDITIONS		ERV OUT	LET CONDITIONS	ENERGY RECOVERY (
EQUIP. NUMBER	MODEL NO.	FLOW	STATIC PRESSURE (EXTERNAL)	FAN MOTORS FAN MOTORS	FLA (FOR UNIT SINGLE POINT)	Volts/ Phase/ Hz	MCA	FUSE/CB MAX	outside air tem (DB) / (W		ROOM AIR TEMP ((DB) / (WE		Leaving air tem (DB) /		COOLING CAPACITY (MBH / TON)	HEATING CAPACITY (MBH)	NOTES:
									SUMMER	WINTER	SUMMER	WINTER	SUMMER	WINTER	TOTAL	TOTAL	
ERV-1	MICROMETL FWVH22ID79000HEF	1100 CFM	0.50IN H ₂ 0	(2) FOR FANS	22.33 A	240V 1 PH 60 HZ	27.91	40	94F / 79F	23F / 19	75F / 50%	72F / 50%	81.6F / 72F	55F / 42F	33.7 / 2.8	47.4	ALL

NOTES:

1. FLOW & LOADS BASED ON ARI-1060 PERFORMANCE & CERTIFIED CORE.

2. NOT USED.

3. VENTILATION TYPE: STATIC PLATE, HEAT & HUMIDITY TRANSFER. 4. INCLUDE INTEGRAL DISPOSABLE FILTERS (OUTSIDE AND ROOM AIR) WITH MERV8 OR BETTER RATING.

5. INCLUDE SINGLE POINT ELECTRICAL POWER CONNECTION.

6. HOUSING SHALL BE GALVANIZED, .20 GAUGE (OR THICKER) STEEL WITH LAPPED CORNERS.

7. OR EQUALS BY SEMCO, OR THYBAR. 8. SERVICE ACCESS DOORS SHALL BE GASKETED & PROVIDE ACCESS FOR MAINTENANCE OF ALL COMPONENTS.

9. INCLUDE INSULATION ON ALL CASE WALLS & DOORS. 10. INCLUDE THERMALLY PROTECTED MOTORS WITH STARTERS.

11. UL LISTED 1995

12. PROVIDE WITH FUSED DISCONNECT SWITCH.

GENERAL NOTES - MECHANICAL

- 1. ALL WORK SHALL BE IN ACCORDANCE WITH THE LATEST EDITION OF THE STATE CODE AND ALL LOCAL AND OTHER APPLICABLE CODES.
- 2. ANY PERMITS AND INSPECTION FEES SHALL BE SECURED AND PAID FOR BY THE MECHANICAL CONTRACTOR (MC).
- 3. ALL WORK SHALL BE PERFORMED BY EXPERIENCED AND SKILLED CRAFTSMEN. THE MC SHALL COORDINATE ALL OF HIS WORK WITH THE GENERAL CONTRACTOR (GC) AND OTHER TRADES.
- 4. THE LOCATION OF ALL DUCT, PIPING AND EQUIPMENT SHALL BE ADJUSTED TO ACCOMMODATE ANTICIPATED OR ENCOUNTERED INTERFERENCES.
- THESE PLANS ARE DIAGRAMMATIC AND MAY NOT SHOW MINOR DETAILS AND LOCATIONS. FOR 5. DIMENSIONS REFER TO THE ARCHITECTURAL PLANS.
- 6. THE MC SHALL BE RESPONSIBLE FOR ALL ELECTRICAL STARTERS INTERLOCKS, CONTROL WIRING CONDUIT AND POWER WIRING FROM DISCONNECTS TO HIS EQUIPMENT, USING A LICENSED ELECTRICIAN.
- THE MC SHALL USE FIRE DAMPERS FOR PROTECTION OF THE OPENING IN ACCORDANCE WITH STATE AND LOCAL CODES IN ALL LOCATIONS WHERE PENETRATIONS OF RATED WALLS AND FLOORS OCCUR. SEE ARCHITECTURAL PLANS FOR RATED WALL AND FLOOR LOCATIONS. PROVIDE ACCESS DOORS AT ALL DAMPER LOCATIONS. LOCATE DOORS FOR EASY ACCESS. THERE ARE NO RATED WALLS PENETRATED IN THIS HVAC UPFIT.
- INSTALL FLEXIBLE CONNECTORS ON SUPPLY AND RETURN DUCTWORK AHU. ALL 8. MECHANICAL EQUIPMENT SHALL OPERATE FREE OF OBJECTIONAL NOISE AND VIBRATION.
- 9. INSTALL TURNING VANES IN SUPPLY DUCTS AT ALL ELBOWS AND SPLITTER DAMPERS. PROVIDE BALANCING DAMPERS IN ALL DUCTS WHERE SHOWN OR REQUIRED FOR SYSTEM BALANCING. PROVIDE SPIN IN STARTING COLLARS WITH DAMPERS AT ALL SUPPLY TAKEOFFS.
- 10. DUCT DIMENSIONS ARE SHOWN INSIDE CLEAR. COORDINATE EXACT SIZE WITH SPACE AVAILABLE DUCT INSULATION SHALL BE 2" FIBERGLASS EXTERIOR DUCT INSULATION WITH FOIL FACING.
- THERMOSTAT, WIRING AND CONDUIT ARE TO BE FURNISHED BY THE MC. MOUNT 11. THERMOSTAT 48" ABOVE THE FINISHED FLOOR. COORDINATE LOCATION WITH OWNER. PROVIDE AUTO CHANGEOVER THERMOSTAT WITH UNIT OFF POSITION AS MINIMUM. PROVIDE AN EMERGENCY SHUT-OFF SWITCH ABOVE THE THERMOSTAT. PROPERLY LABEL SHUT-OFF SMTCH.
- 12. THE MC SHALL KEEP THE PREMISES CLEAR OF DEBRIS FROM HIS WORK DURING CONSTRUCTION AND LEAVE THE AREA AND BUILDING CLEAN AT THE COMPLETION OF HIS WORK. HE SHALL ALSO LEAVE CLEAN ALL EXPOSED EQUIPMENT IN HIS CONTRACT.
- 13. COORDINATE DIFFUSER AND CEILING EXHAUST GRILLE LOCATIONS WITH LIGHTS AND GRID. COORDINATE MOUNTING FRAME WITH CEILING TYPE.
- 14. THE M.C. SHALL COORDINATE WITH AND PROVIDE EQUIPMENT SPEC. SHEETS TO THE GENERAL AND ELECTRICAL CONTRACTORS FOR REVIEW PRIOR TO ORDERING EQUIPMENT.
- 15. PROPERLY SUPPORT FLEXIBLE DUCT, MINIMUM 75% DEFORMATION. PROVIDE SHEET METAL ELBOWS AT ALL 90 DEGREE BENDS.
- 16. ALL DUCT JOINTS SHALL BE SEALED AIRTIGHT WITH FIBER ENPREGNATED MASTIC OR HARDCAST AND TAPE.
- 17. SUPPORT AHU, EXHAUST FANS, HEAT WHEEL AND ALL DUCTWORK, ETC. FROM STRUCTURE. PIPE STRAPPING WILL NOT BE ALLOWED.

Prescriptive

Thermal Zone


winter dry bulb

winter dry bulb


APPLICATION TOLIET ROOMS


APPLICATION

APPLICATION STORAGE

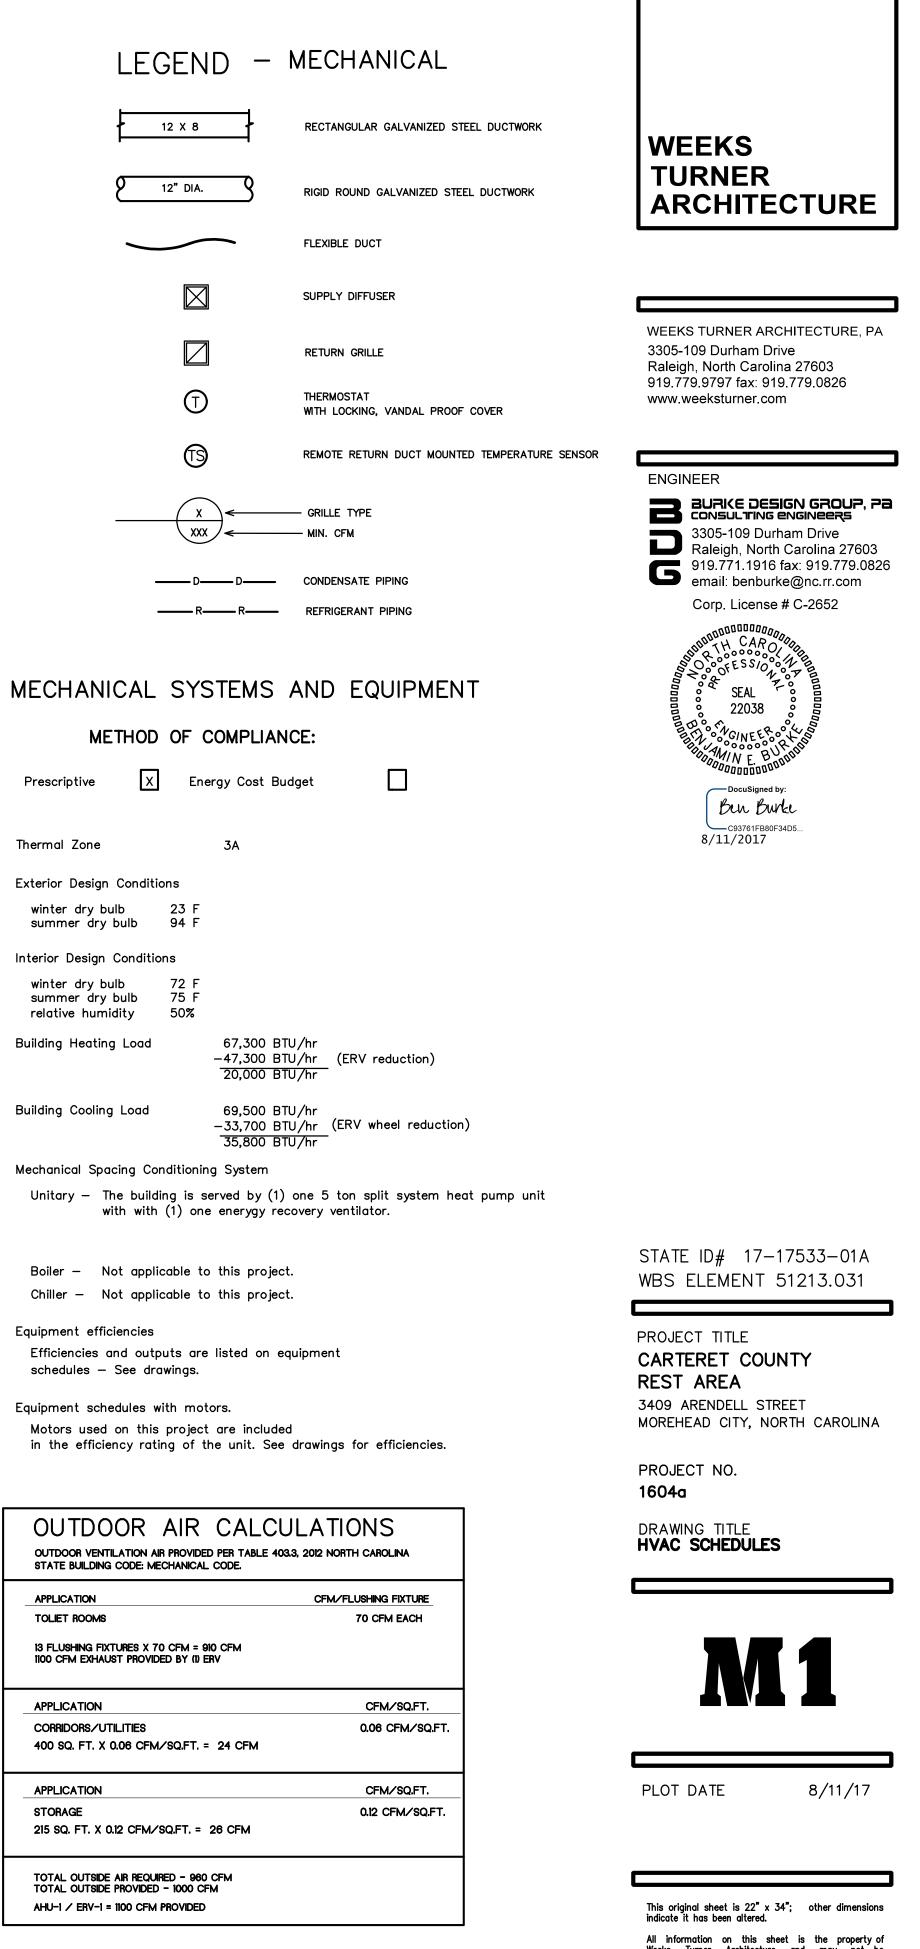


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1 DEMO HVAC PLAN SCALE: 1/4" = 1'-0"

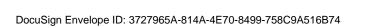NOTE: THE EXISTING INFORMATION SHOWN ON THIS DRAWING IS FROM FIELD INVESTIGATION AND PREVIOUS PERMIT DRAWINGS. THE CONTRACTOR IS RESPONSIBLE FOR VISITING THE SITE AND FIELD VERIFYING ALL RELEVANT INFORMATION. THE SUBMISSION OF A BID INDICATES ACCEPTANCE OF EXISTING CONDITIONS. NOTIFY THE ENGINEER OF ANY DISCREPANCIES NOTED.

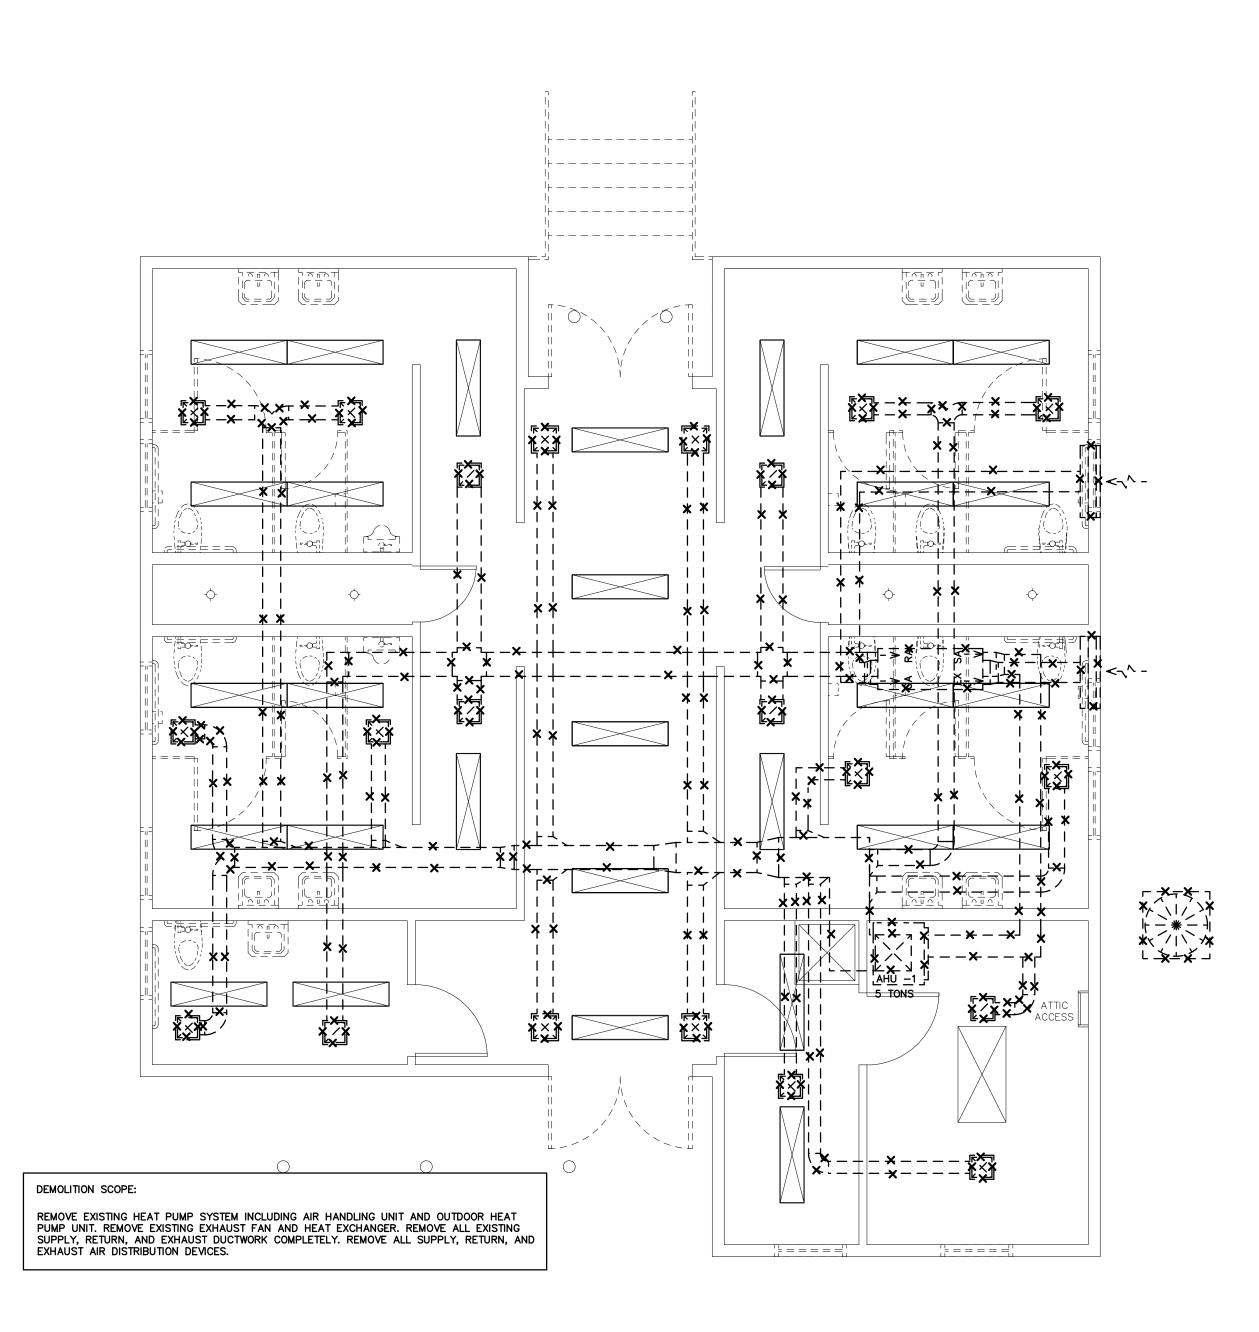

2 REVISED HVAC PLAN SCALE: 1/4" = 1'-0"


KEY NOTES FOR 2/M2

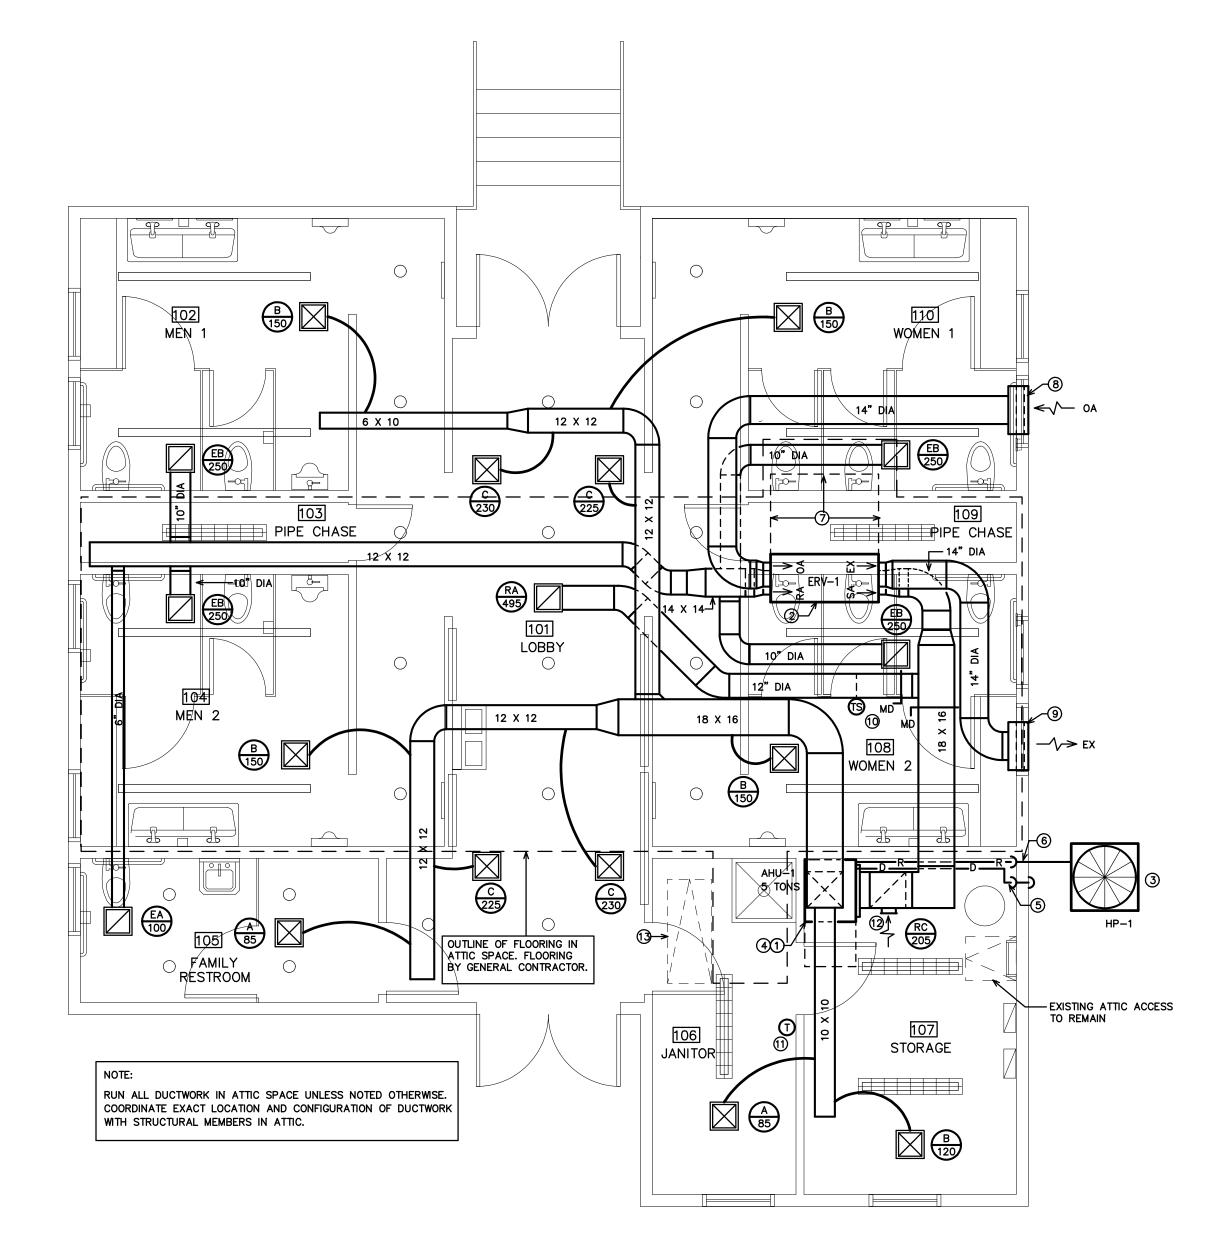- () VERTICAL AIR HANDLING UNIT MOUNTED ON FLOOR. SEE DETAIL 1/M3
- (2) ERV IN ATTIC MECHANICAL SPACE. SEE DETAIL 2/M3.
- (3) HEAT PUMP UNIT MOUNTED ON A 4" THICK" POURED IN PLACE" CONCRETE PAD.
- (4) PROVIDE DRAIN PAN UNDER AHU FOR THE FULL LENGTH. PROVIDE FLOAT SWITCH IN PAN FOR OVERFLOW. WRE TO SHUT DOWN UNIT.
- (5) RUN PVC CONDENSATE DRAIN TO THE EXTERIOR. INSULATE THE ENTIRE LENGTH. TURN DOWN INTO THE PLANTING AREA.
- (6) RUN THE REFRIGERANT LINES THROUGH THE EXTERIOR WALL. SEAL WALL PENETRATION. PAINT ALL EXPOSED, EXTERIOR INSULATION WITH UV RESISTANT PAINT.
- (7) MANUFACTURERS' REQUIRED SERVICE CLEARANCE FOR ERV.
- (8) OUTSIDE AIR INTAKE LOUVER MOUNTED ON GABLE END OF BUILDING. SEE ARCHITECTURAL ELEVATIONS FOR EXACT LOUVER LOCATION. LOUVER SHALL BE 10'-0" MIN FROM ANY EXHAUST DISCHARGE. LOUVER SHALL EQUAL TO CARNES MODEL FSWC HURRICANE LOUVER. SIZE, 30" X 30". COLOR SELECTED BY ARCHITECT. PROVIDED & INSTALLED BY GC. MC TO COORDINATE WITH GC AND PROVIDE DUCT CONNECTION AS REQUIRED.
- (9) EXHAUST AIR LOUVER MOUNTED ON GABLE END OF BUILDING. SEE ARCHITECTURAL ELEVATIONS FOR EXACT LOUVER LOCATION. LOUVER SHALL BE 10'-0" MIN FROM ANY OUTSIDE AIR INTAKE. LOUVER SHALL EQUAL TO CARNES MODEL FSWC HURRICANE LOUVER. SIZE, 30" X 30". COLOR SELECTED BY ARCHITECT. PROVIDED & INSTALLED BY GC. MC TO COORDINATE WITH GC AND PROVIDE DUCT CONNECTION AS REQUIRED.
- 10 REMOTE DUCT MOUNTED TEMPERATURE SENSOR.
- (1) WALL MOUNTED THERMOSTATS. MOUNT AT 48" AFF.
- (2) RETURN AIR GRILLE MOUNTED ON SIDE OF VERTICAL RETURN AIR DUCT.
- (3) NEW CEILING ATTIC ACCESS BY GENERAL CONTRACTOR. ACCESS SHALL BE SIZED TO ALLOW FOR NEW ERV INSTALLATION AND REMOVAL.



WEEKS TURNER ARCHITECTURE

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STATE ID# 17-17533-01A WBS ELEMENT 51213.031

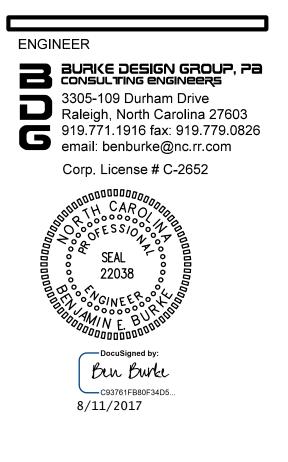PROJECT TITLE CARTERET COUNTY REST AREA 3409 ARENDELL STREET MOREHEAD CITY, NORTH CAROLINA

PROJECT NO. **1604a**


DRAWING TITLE HVAC PLANS



PLOT DATE

8/11/17


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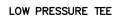


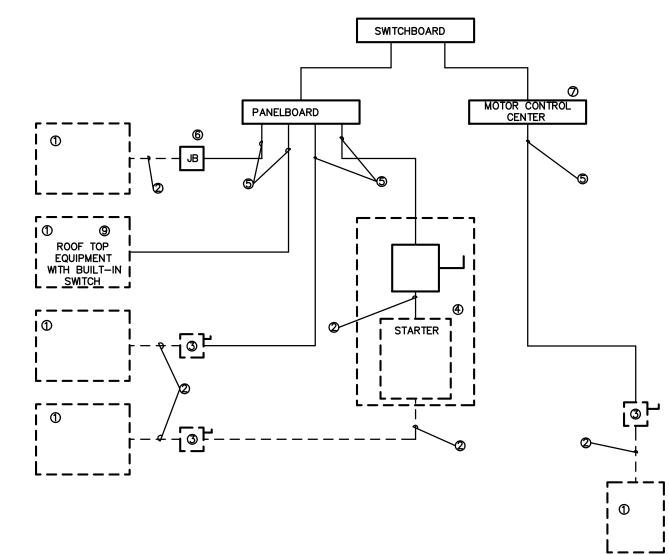
4 ELECTRICAL EQUIPMENT CONNECTION

KEY NOTES FOR ELECTRICAL CONNECTION DRAWING 1/M1


- (1) EQUIPMENT OF TRADES OTHER THAN ELECTRICAL.
- (2) CONDUIT & WIRING BY HVAC PLUMBING CONTRACTOR, OR OTHER TRADES
- ③ IF AN ADDITIONAL DISCONNECT IS REQUIRED BY NEC, IT SHALL BE PROVIDED AND INSTALLED BY THE EQUIPMENT CONTRACTOR.
- A COMBINATION STARTER OR VFD MAY BE USED IN LIEU OF A SEPARATE DISCONNECT SWITCH AND STARTER. LOCATE ADJACENT TO EQUIPMENT.
- (5) FEEDER CIRCUIT WIRING AND CONDUIT IN ELECTRICAL WORK. SEE PANELBOARD SCHEDULES FOR WIRE AND BREAKER SIZES.
- (6) JUNCTION BOX MAY BE SHOWN ON ELECTRICAL PLANS FOR SOME EQUIPMENT IF NO STARTER OR DISCONNECT IS SUPPLIED, A JUNCTION BOX SHALL BE INSTALLED ADJACENT TO EQUIPMENT. THE ELECTRICAL CONTRACTOR SHALL PROVIDE LINE SIDE WRING TO THE JUNCTION BOX. LOAD SIDE WRING WILL BE PROVIDED BY MECHANICAL CONTRACTOR OR OTHER TRADES.
- PROJECTS UTILIZING AN MCC. THE STARTER, CB, OR VFD IN THE MCC ARE PROVIDED BY THE ELECTRICAL CONTACTOR.
- (8) IN ALL CASES THE EQUIPMENT CONTRACTOR SHALL MAKE FINAL CONNECTIONS, START UP, AND TEST EQUIPMENT.
- (9) IF THE ROOF TOP EQUIPMENT IS NOT PROVIDED WITH BUILT IN SWITCH, THE ELECTRICAL CONTRACTOR SHALL PROVIDE A DISCONNECT SWITCH.
- () IN A SINGLE PRIME CONTRACT, IT IS THE RESPONSIBITY OF THE PRIME CONTACTOR TO COORDINATE BETWEEN THE ELECTRICAL AND OTHERS TRADES.



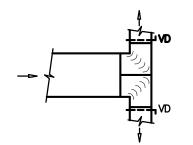


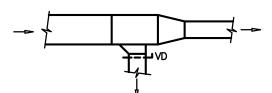

LOW PRESSURE BRANCH TAKE-OFF

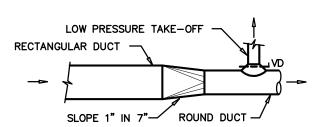


RECTANGULAR TO ROUND TRANSITION

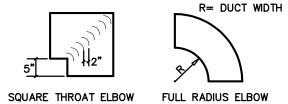


LOW PRESSURE DUCT ELBOWS



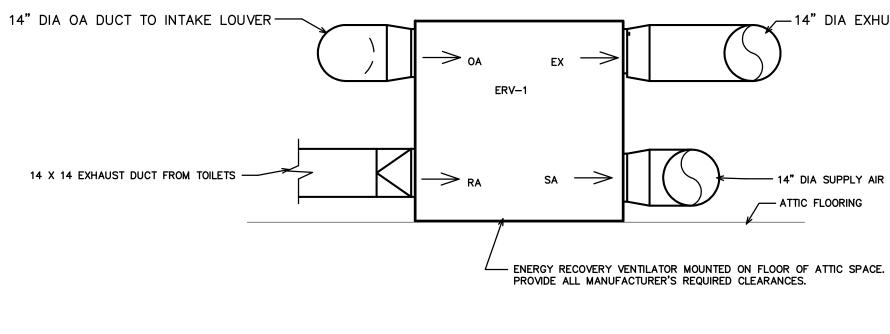



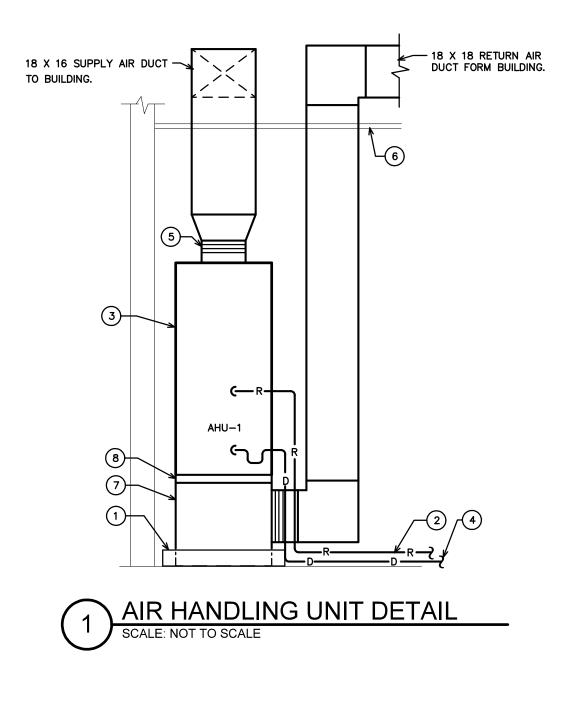

KEY NOTES FOR 1/M3

- (1) GALVANIZED STEEL DRAIN PAN. PROVIDE FLOAT SWITCH TO SHUT-DOWN UNIT.
- 2 REFRIGERANT LINE SET, SIZED PER MANUFACTURER'S INSTRUCTIONS RUN TO OUTDOOR HEAT PUMP UNIT AT GRADE.
- 3 VERTICAL AIR HANDLING UNIT MOUNTED ON FLOOR. PROVIDE ALL MANUFACTURER'S REQUIRED CLEARANCES.
- (4) RUN CONDENSATE PIPE TO EXTERIOR. INSUALATE ENTIRE LENGTH WITH CLOSED CELL INSULATION.
- \bigcirc Flexible connections on all duct connections to equipment. (Typical).
- 6 FINISH CEILING.
- \bigodot return air plenum on bottom of air handling unit full size of return air opening on unit.
- 8 FACTORY FILTER SECTION WITH HINGED DOOR.

-14" DIA EXHUAST DUCT TO EXHAUST LOUVER

14" DIA SUPPLY AIR DUCT TO AIR HANDLING UNIT

E.

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STATE ID# 17-17533-01A WBS ELEMENT 51213.031

PROJECT TITLE CARTERET COUNTY REST AREA 3409 ARENDELL STREET MOREHEAD CITY, NORTH CAROLINA

PROJECT NO. **1604a**

DRAWING TITLE **HVAC DETAILS**




PLOT DATE

8/11/17

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	PLUMBING FIXTURE SCH	HEDULE *	
MARK	DESCRIPTION	ALTERNATE MANUFACTURER/MODEL	ALTERNATE MANUFACTU
WC1	WATER CLOSET (FLOOR MOUNT TOP SPUD) AMERICAN STANDARD "MADERA FLOWISE" #3461.001, ELONGATED BOWL, 1.28 GPF, VITREOUS CHINA, AND 1 1/2" TOP SPUD, ADA COMPLIANT. PROVIDE OPEN FRONT SEAT, AND SENSOR W/ MANUAL OVERRIDE FLUSH VALVE EQUAL TO SLOAN OPTIMA 111-1.28-ES-S (AC POWERED) FLUSH VALVE.	ZURN #Z5665 FIXTURE. ZURN #ZEMS6000IS FLUSH VALVE.	Kohler Highcrest # K- Hydrotek H8—128 Valv
WC2	WATER CLOSET (FLOOR MOUNT REAR OUTLET W/BACK SPUD) AMERICAN STANDARD "PRIOLO FLOWISE" #3697.001, ELONGATED BOWL, 1.28 GPF, VITREOUS CHINA, AND 1 1/2" BACK SPUD. WC TO BE ADA COMPLIANT. PROVIDE OPEN FRONT SEAT, AND SENSOR W/ MANUAL OVERRIDE FLUSH VALVE, EQUAL TO SLOAN OPTIMA 140-1.28-ES-S (AC POWERED) FLUSH VALVE.	ZURN Z5647—BWL FIXTURE, ZURN #ZEMS6152AV—HET, 1.28 GPF VALVE.	Fixture—No 3rd Choice Hydrotek H—8cb—128, 1
WC3	WATER CLOSET (WALL MOUNT BACK SPUD) AMERICAN STANDARD "AFWALL FLOWISE" #3353.128, ELONGATED BOWL, 1.28 GPF, VITREOUS CHINA, AND 1 1/2" BACK SPUD. WC3 TO BE ADA COMPLIANT WHERE REQUIRED. PROVIDE OPEN FRONT SEAT, AND SENSOR W/ MANUAL OVERRIDE FLUSH VALVE, EQUAL TO SLOAN OPTIMA MODEL 152–1.28–ES–S (AC POWERED) FLUSH VALVE. CARRIER SHALL BE ZURN 4" ADJUSTABLE VERTICAL NO HUB #Z1204–N4–X W/HEAVY–DUTY 500 LB. REAR ANCHOR.	ZURN #Z5617 FIXTURE. ZURN #ZEMS6140AV FLUSH VALVE. JAY R. SMITH #230 SERIES CARRIER.	KOHLER KINGSTON #K—4 HYDROTEK H—8000C—CE JOSAM STD. 4" NO HUB
TPV	TRAP PRIMER VALVE PPP INC. MODEL# PR-500, 1/2" INLET, 1/2" OUTLET	JOSAM #88300.	WATTS #A200.
EWH-1	ELECTRIC WATER HEATER #1 (PROVIDES HTHW) A.O. SMITH MODEL EJC-10, 10 GALLON, 1,650 WATT, 3/4" INLET AND OUTLET, 120V. AO SMITH MODEL #PMC-2 EXPANSION TANK.	RHEEM #81VP10S. AMTROL ST-5-C EXPANSION TANK.	BRADFORD WHITE #M-1- STATE ETC-2X EXPANSIO
EWH-2	ELECTRIC WATER HEATER #2 (PROVIDES HTHW/LTHW) AO SMITH WATER HEATER MODEL #DEN-52, 50 GALLONS, 4500 WATT, 240 VOLT, NON- SIMULTANEOUS DUAL ELEMENTS, 3/4" INLET/OUTLET, AO SMITH MODEL #PMC-2 EXPANSION TANK.	BRADFORD WHITE #LD-50R3-3. AMTROL ST-5-C EXPANSION TANK.	STATE #ES6-50-DORT. STATE ETC-2X EXPANSIO
СР	CIRCULATING PUMP BELL & GOSSET, SERIES NBF-22 IN-LINE CIRCULATOR PUMP, 1/12 HP, 115 VAC, FLA=0.8 1 Ph., 3/4" CONN., WITH A MAXIMUM OF 22 GPM AND 15' TDH. PUMP TO BE ALL BRONZE CONSTRUCTION, COORDINATE WITH ELEC. CONTRACTOR FOR POWER FEED. PROVIDE DISCONNECT SWITCH, AQUASTAT CONTROL, THERMOMETER/TEMPERATURE GAUGES.	TACO MODEL #110.	ARMSTRONG MODEL #S-2
UR	URINAL AMERICAN STANDARD "WASHBROOK" #6515.001, 1.0 GPF, VITREOUS CHINA, 3/4" BACK SPUD, AND SENSOR W/ MANUAL OVERRIDE FLUSH VALVE SLOAN #195-1.0-ES-S-OR (AC POWERED). ADA COMPLIANT.	ZURN #5760 WITH ZURN ZEMS6195AV-OB FLUSH VALVE.	TOTO #UT104EV WITH TOT FLUSH VALVE.
L1	LAVATORY (ACCESSIBLE, WALL HUNG) AMERICAN STANDARD "LUCERNE" # 0356.421 WHITE WITH CONCEALED ARM CARRIER AND DRAIN ASSEMBLY (7723.018). ADA COMPLIANT. FURNISH WITH SLOAN OPTIMA EAF-275 SOLAR POWERED FAUCET. SINK MODEL FOR SINGLE CENTER HOLE.	KOHLER GREENWICH #K-2032 WITH HYDROTEK 7000SLE SOLAR SENSOR FAUCET.	ELJER MURRAY II #051-0 TOTO TEL3GS10 SOLAR SEI
L2	2- STATION LAVATORY (ACCESSIBLE) SLOAN SLOANSTONE TWO STATION LAVATORY #ELS-72275, 2 DRAINS W/GRID STRAINERS, ADA COMPLIANT. COLOR MWN WALNUT (VERIFY). FURNISH WITH SLOAN EAF-275 SOLAR POWERED FAUCETS.	BRADLEY TERREON ELX-2A WITH JUST JSG-7000 SOLAR SENSOR FAUCETS.	WLLOUGHBY MODEL WAW- TOTO TEL3GS10 SOLAR SE
DF	DRINKING FOUNTAIN (HI-LO ADA, FILTERED NON-REFRIGERATED, ACCESSORY APRON FOR HIGH UNIT) ELKAY LZWS-EDFPBM117K WITH BOTTLE FILLER, ACCESSORY CANE APRON LKAPR1. COORDINATE WITH ARCH FOR MOUNTING HEIGHTS, VERIFY MODEL FOR HI/LO LOCATIONS (1-LOW/ADA HEIGHT, 1-HIGH).	HALSEY-TAYLOR MODEL #HTHBWR-OVLSEBP-I. ACCESSORY APRON HTOVLAPR.	OASIS MODEL #MMRSLSE STNLS. STL. ACCESSORY
FD	FLOOR DRAIN ZURN ZN-415 WITH DEEP SEAL P-TRAP, 5" X 5" TYPE "S" SQUARE STRAINER AND 3" CONNECTION, VANDAL-PROOF TOP. PROVIDE MODEL WITH TRAP PRIMER CONNECTION.	JOSAM #30000-S.	JAY R. SMITH #2005–B.
НВ	HOSE BIBB ZURN Z–1330–C, 3/4" WALL HYDRANT WITH VANDAL RESISTANT VACUUM BREAKER. ENCASED WITH KEY LOCK.	WATTS #HY-330.	JAY R. SMITH #5509QT.
тм∨	THERMOSTATIC MIXING VALVE (VERIFY IF REQUIRED- SEE KEY NOTES SHEET P3) WATTS MMV-M1 MIXING VALVE WITH CHECKSTOPS. 1" INLETS. INSTALL IN ACCESSIBLE LOCATION. SET OUTFLOW TO SPECIFIED TEMPERATURE (LTHW/110 DEG F.).	LEONARD TM SERIES.	TACO 5000 SERIES.

*OR APPROVED EQUAL

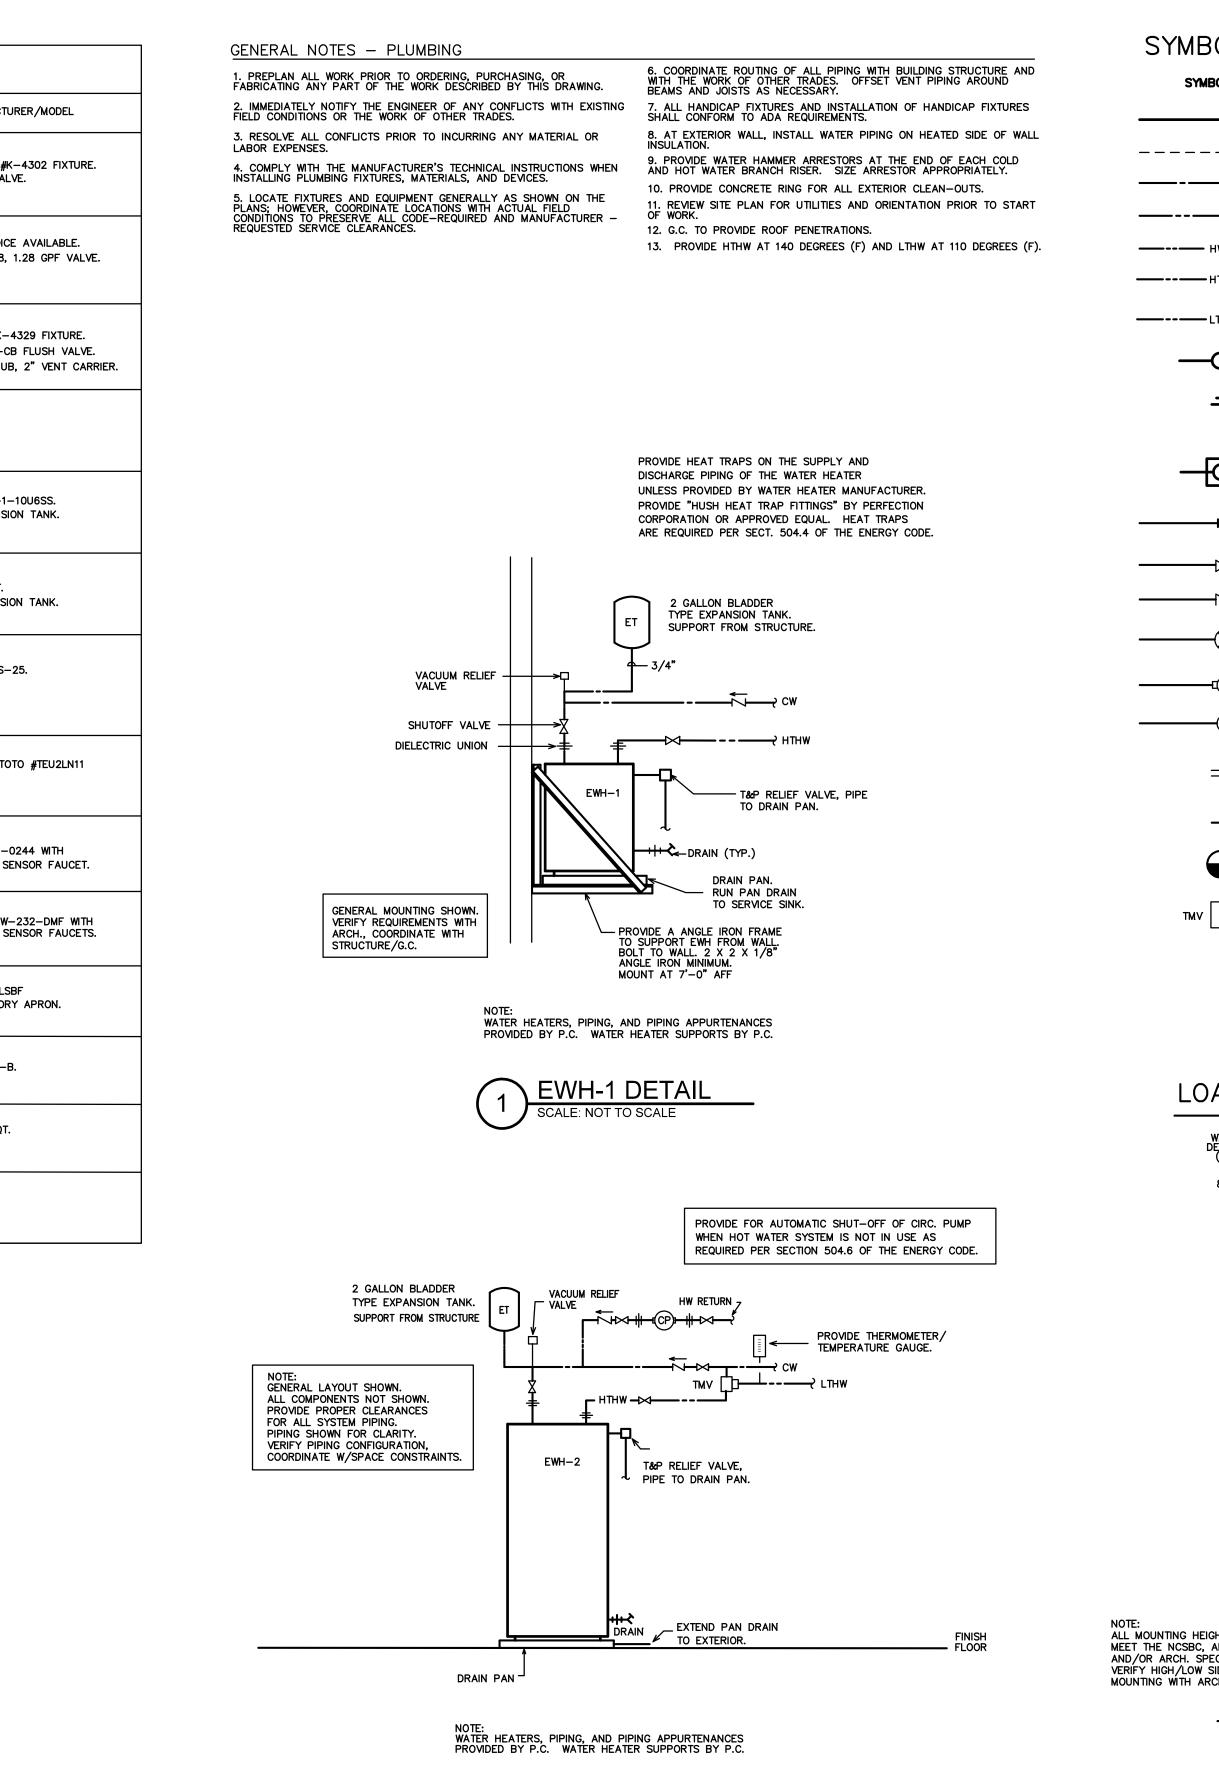


SEWH-2 DETAIL

SCALE: NOT TO SCALE

SYMBOL LEGEND - PLUMBING

IBOL	

MBOL	DESCRIPTION
	WASTE PIPING (W)
	VENT PIPING (V)
	COLD WATER PIPING (CW)
	HOT WATER PIPING (HW)
— HWR ——————	HOT WATER RETURN PIPING (HWR)
— HTHW —————	HIGH TEMPERATURE HW PIPING (HTHW) 140 DEG. F
— LTHW —————	LOW TEMPERATURE HW PIPING (LTHW) 110 DEG. F
-O COFF	CLEANOUT FINISH FLOOR
Т wco/нсо	WALL/HORIZONTAL CLEANOUT
COFG	CLEANOUT FINISH GRADE PROVIDE FLUSH CONCRETE COLLAR AND BRONZE COVER
	DIELECTRIC UNION
	SHUT-OFF VALVE
	CHECK VALVE
	BALANCING VALVE
	CIRCULATION PUMP (CP)
	WATER METER (MTR)
+	VENT THRU ROOF (VTR)
-#-	FREEZE PROOF, HOSE BIBB (FPHB/HB)
\bullet	POINT OF NEW CONNECTION TO EXISTING
v 🗋	THERMOSTATIC MIXING VALVE (TMV)

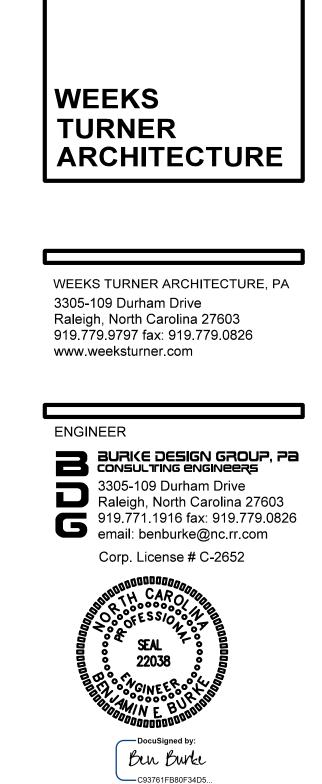

8/11/2017

LOAD SUMMARY- PLUMBING

WASTE DEMAND (FU)	WATER DEMAND (FU)	WATER DEMAND (GPM)	
85.0	140.5	77.1	
A 2" CW SERVICE/RPZ ARE EXISTING.			

STATE ID# 17-17533-01A

BOTTLE FILLING	CARTERET REST AREA 3409 ARENDELI MOREHEAD CITY
	PROJECT NO. 1604a
	DRAWING TITL PLUMBING SPECIFICATION
HEIGHTS SHALL BEC, ADA STANDARD . SPECIFICATIONS. OW SIDE AND 1 ARCH.	
3 DF DETAIL SCALE: NOT TO SCALE	PLOT DATE


WBS ELEMENT 51213.031 PROJECT TITLE

CARTERET COUNTY REST AREA
3409 ARENDELL STREET MOREHEAD CITY, NORTH CAROLINA
PROJECT NO. 1604a
DRAWING TITLE PLUMBING SPECIFICATIONS
P1


8/11/17

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NOTE:

KEY NOTES FOR SHEET P2

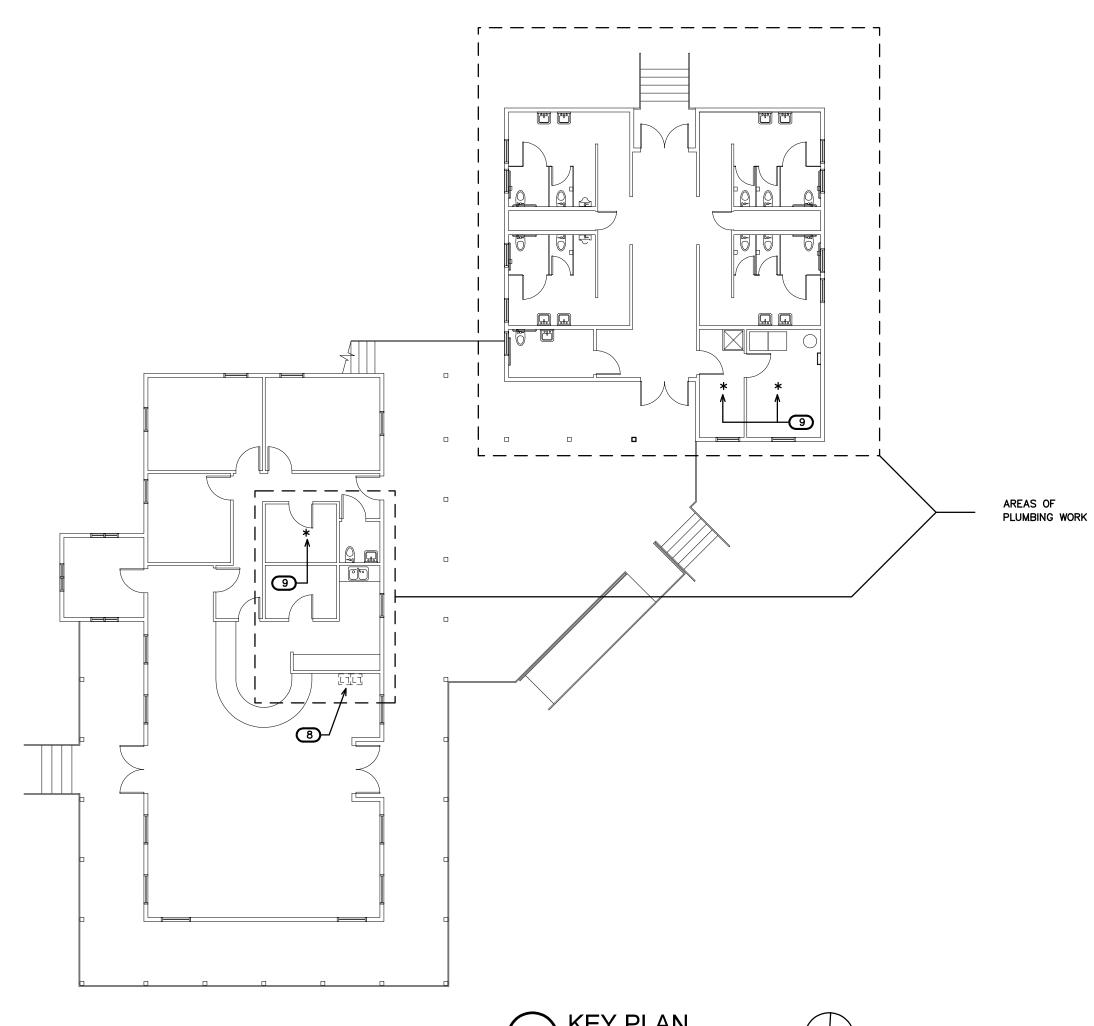2 LAVATORY TO BE REMOVED.


1 WATER CLOSET TO BE REMOVED.

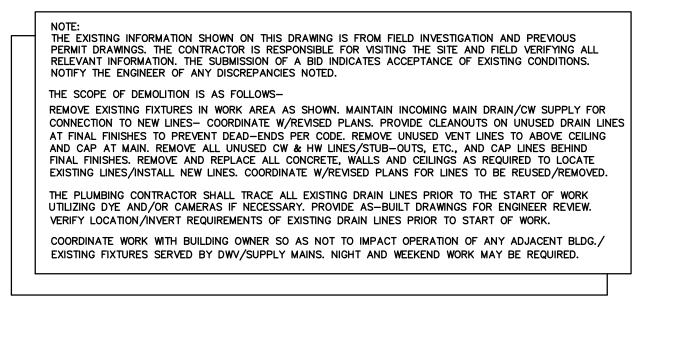
- 3 URINAL TO BE REMOVED.
- 4 ELECTRIC WATER HEATER TO BE REMOVED.


5 SERVICE SINK TO BE REMOVED.

6 FLOOR DRAIN TO BE REMOVED.

- 7 WALL-HUNG WATER CLOSET TO BE REMOVED AND REPLACED W/FLOOR MOUNTED UNIT. GC TO REPLACE FLOORING. COORDINATE FOR NEW UNIT REQUIREMENTS.
- B ELECTRIC WATER COOLER TO BE REMOVED. REMOVE DWV/SUPPLY BACK TO MAINS/CAP AS REQUIRED.
- 9 REMOVE SPRINKLER HEAD SUPPLIED FROM DOMESTIC WATER MAIN. REMOVE

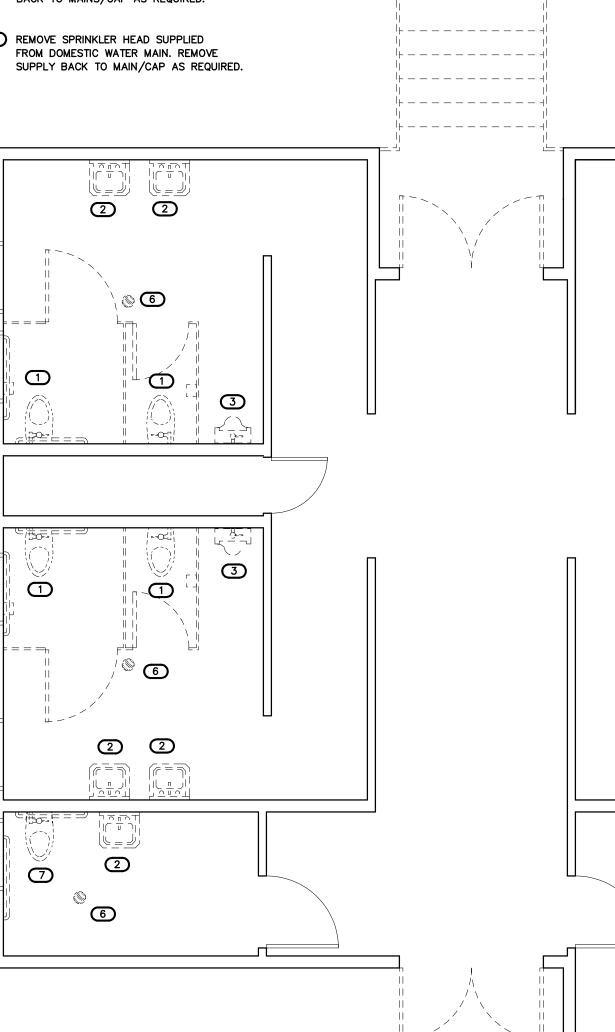


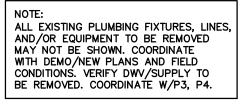

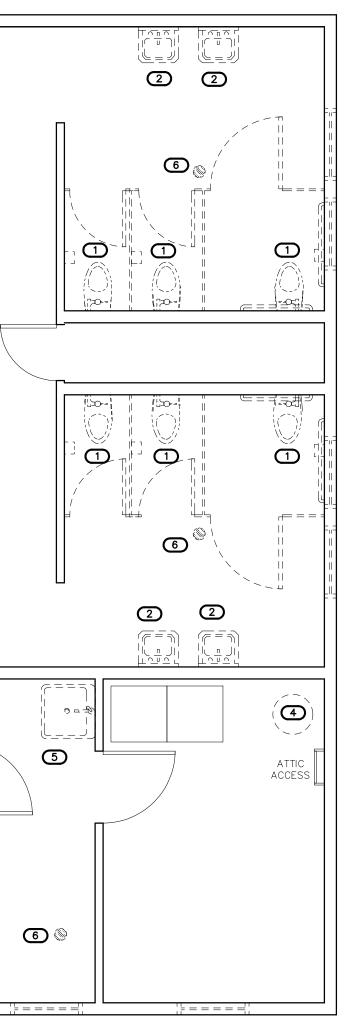



WEEKS TURNER ARCHITECTURE, PA 3305-109 Durham Drive Raleigh, North Carolina 27603 919.779.9797 fax: 919.779.0826 www.weeksturner.com

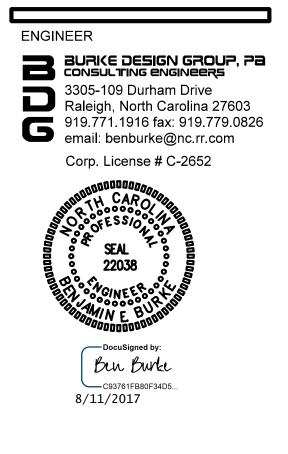

STATE ID# 17-17533-01A		
WBS	ELEMENT	51213.031

PROJECT TITLE CARTERET COUNTY REST AREA 3409 ARENDELL STREET MOREHEAD CITY, NORTH CAROLINA

PROJECT NO. 160**4**a


DRAWING TITLE DEMO PLAN



PLOT DATE

8/11/17

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PIPE SIZING SCHEDULE			
FIXTURE TYPE	DRAIN	VENT	
(WC) FLUSH VALVE WATER CLOSET	3"	1 1/2"	
(L) LAVATORY	3"	1 1/2"	
(S1) SERVICE SINK	1 1/2"	1 1/4"	
(UR) URINAL	2"	1 1/2"	
(DF) DRIINKING FOUNTAIN	1 1/4"	1 1/4"	
(FD) FLOOR DRAIN	3"	1 1/2"	

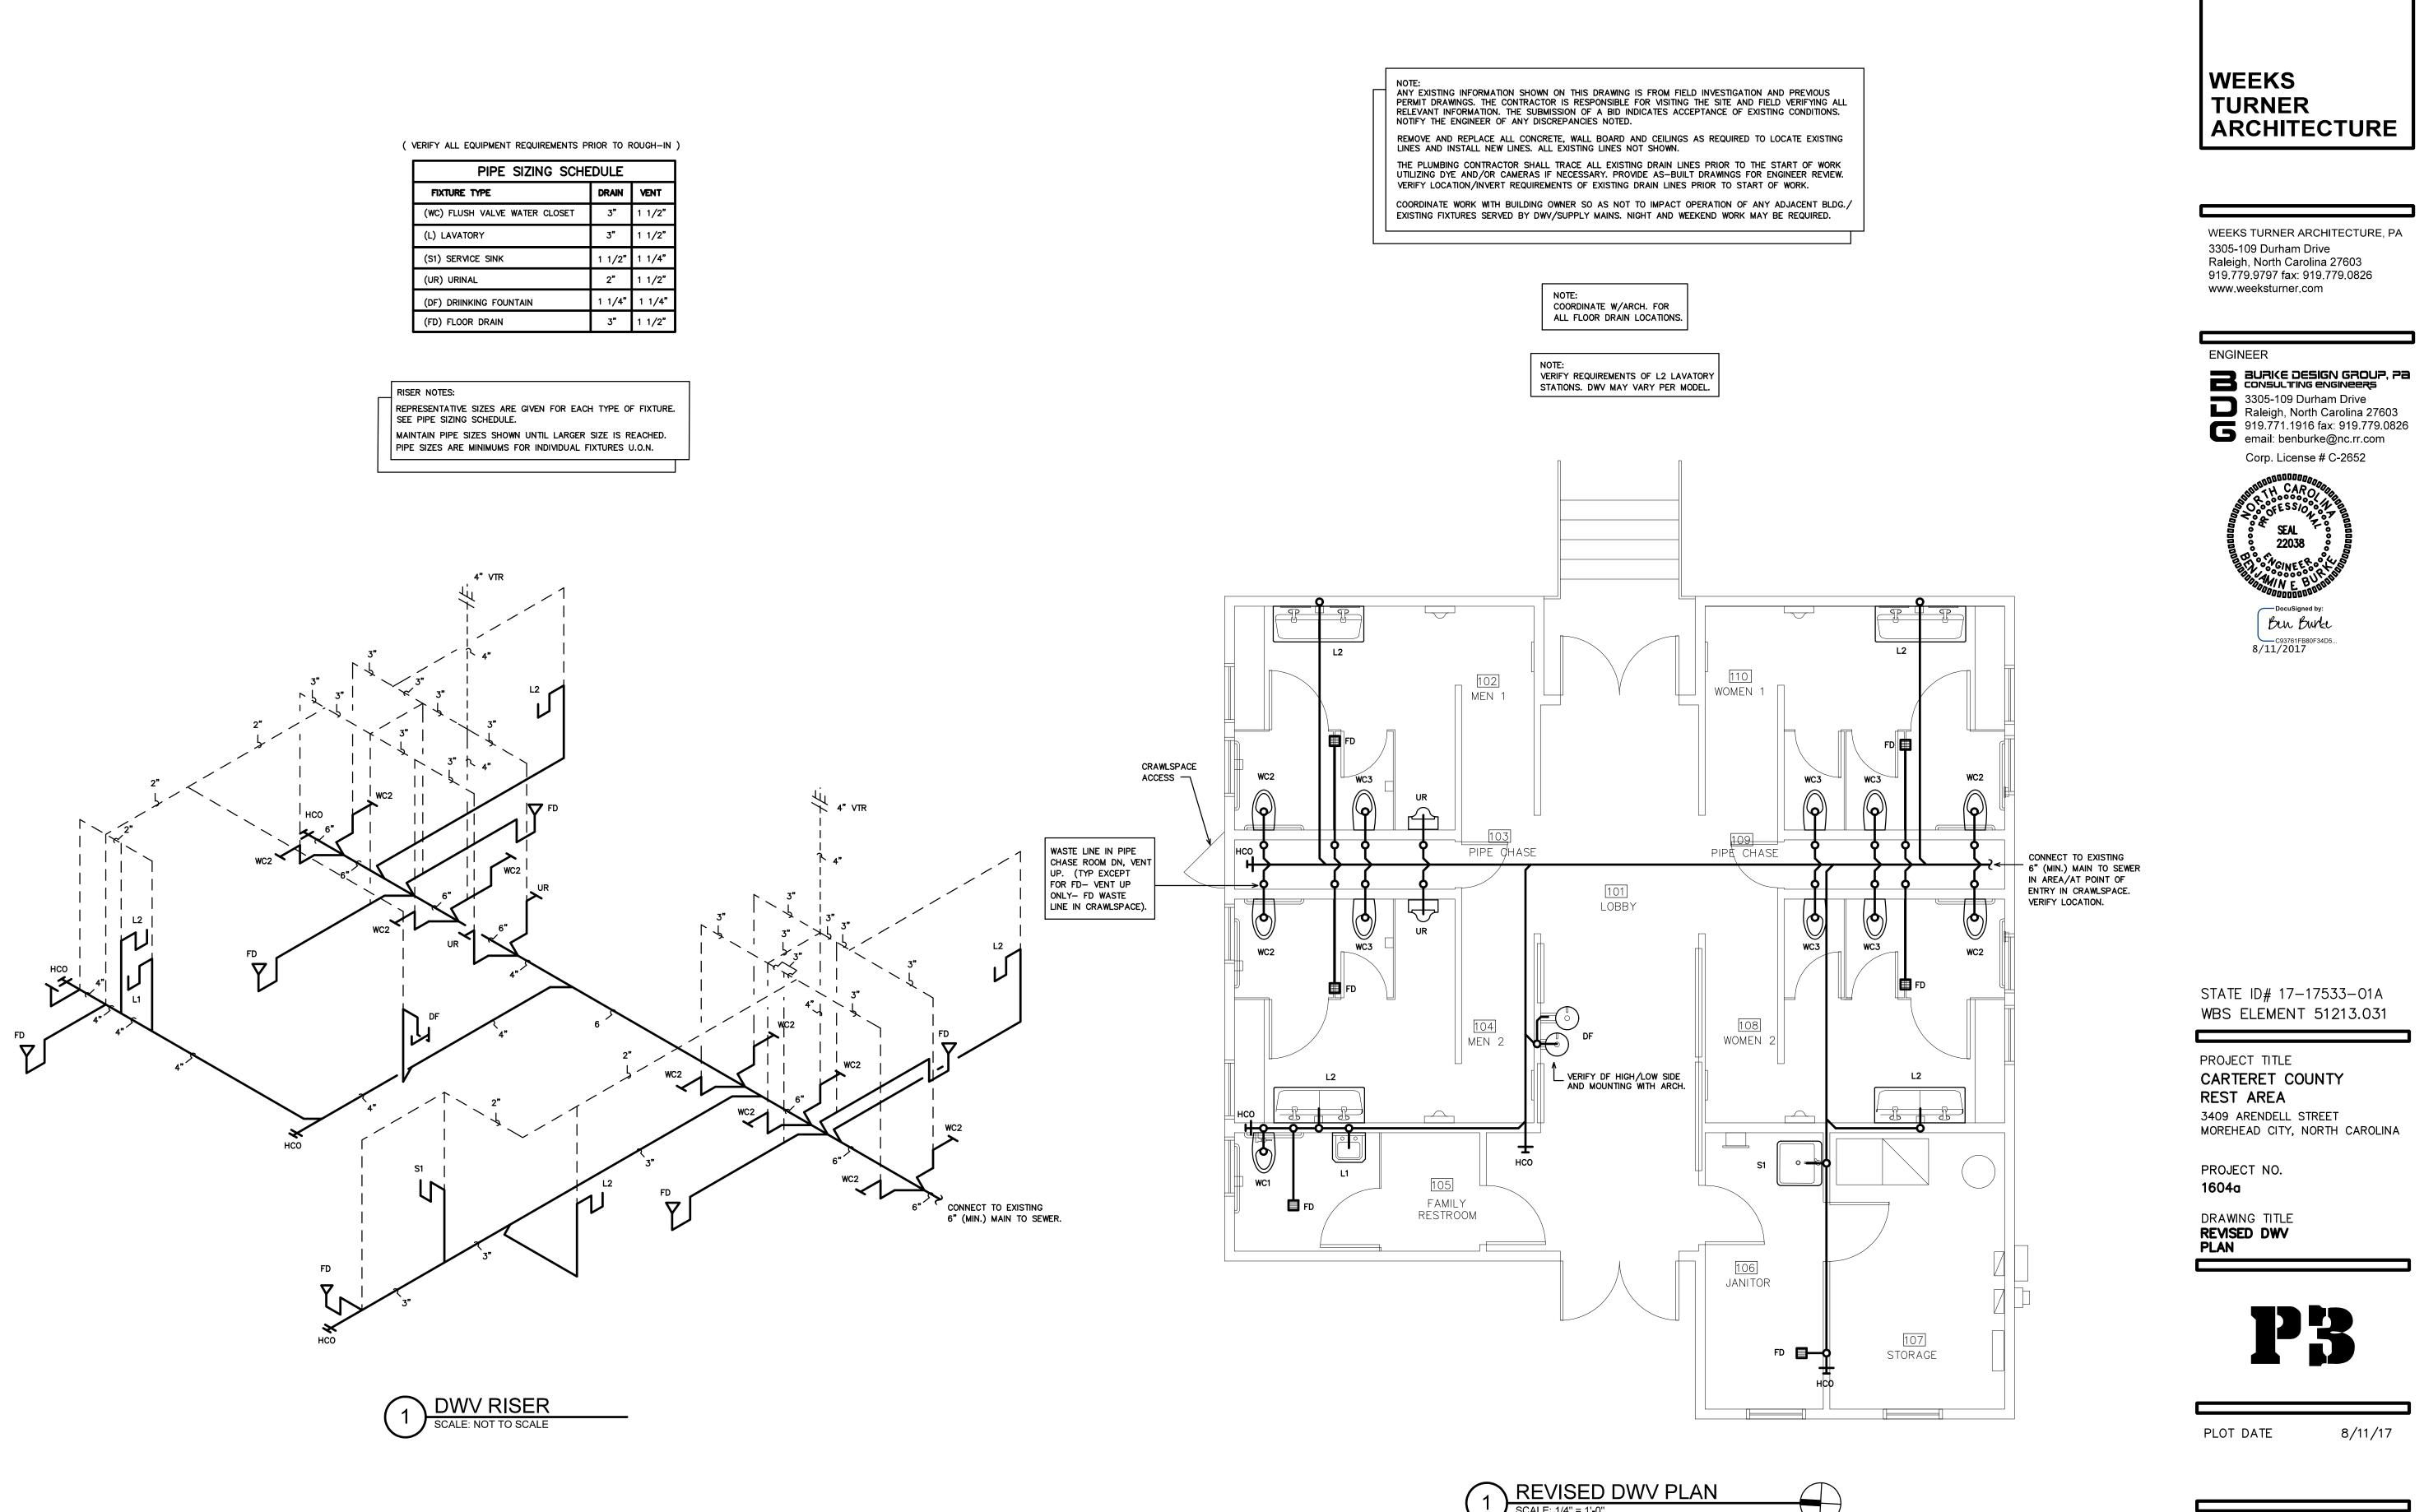
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SCALE: 1/4" = 1'-0"


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(VERIFY ALL EQUIPMENT REQUIREMENTS PRIOR TO ROUGH-IN)

PIPE SIZING SCHEDULE			
FIXTURE TYPE	CW	HW	
(WC) FLUSH VALVE WATER CLOSET	1"	-	
(L) LAVATORY	1/2"	1/2"	
(S1) SERVICE SINK	1/2"	1/2"	
(UR) URINAL	3/4"	-	
(DF) DRIINKING FOUNTAIN	1/2"*	-	
(HB) HOSE BIBB	1/2"	_	
(TPV) TRAP PRIMER VALVE	1/2"	_	





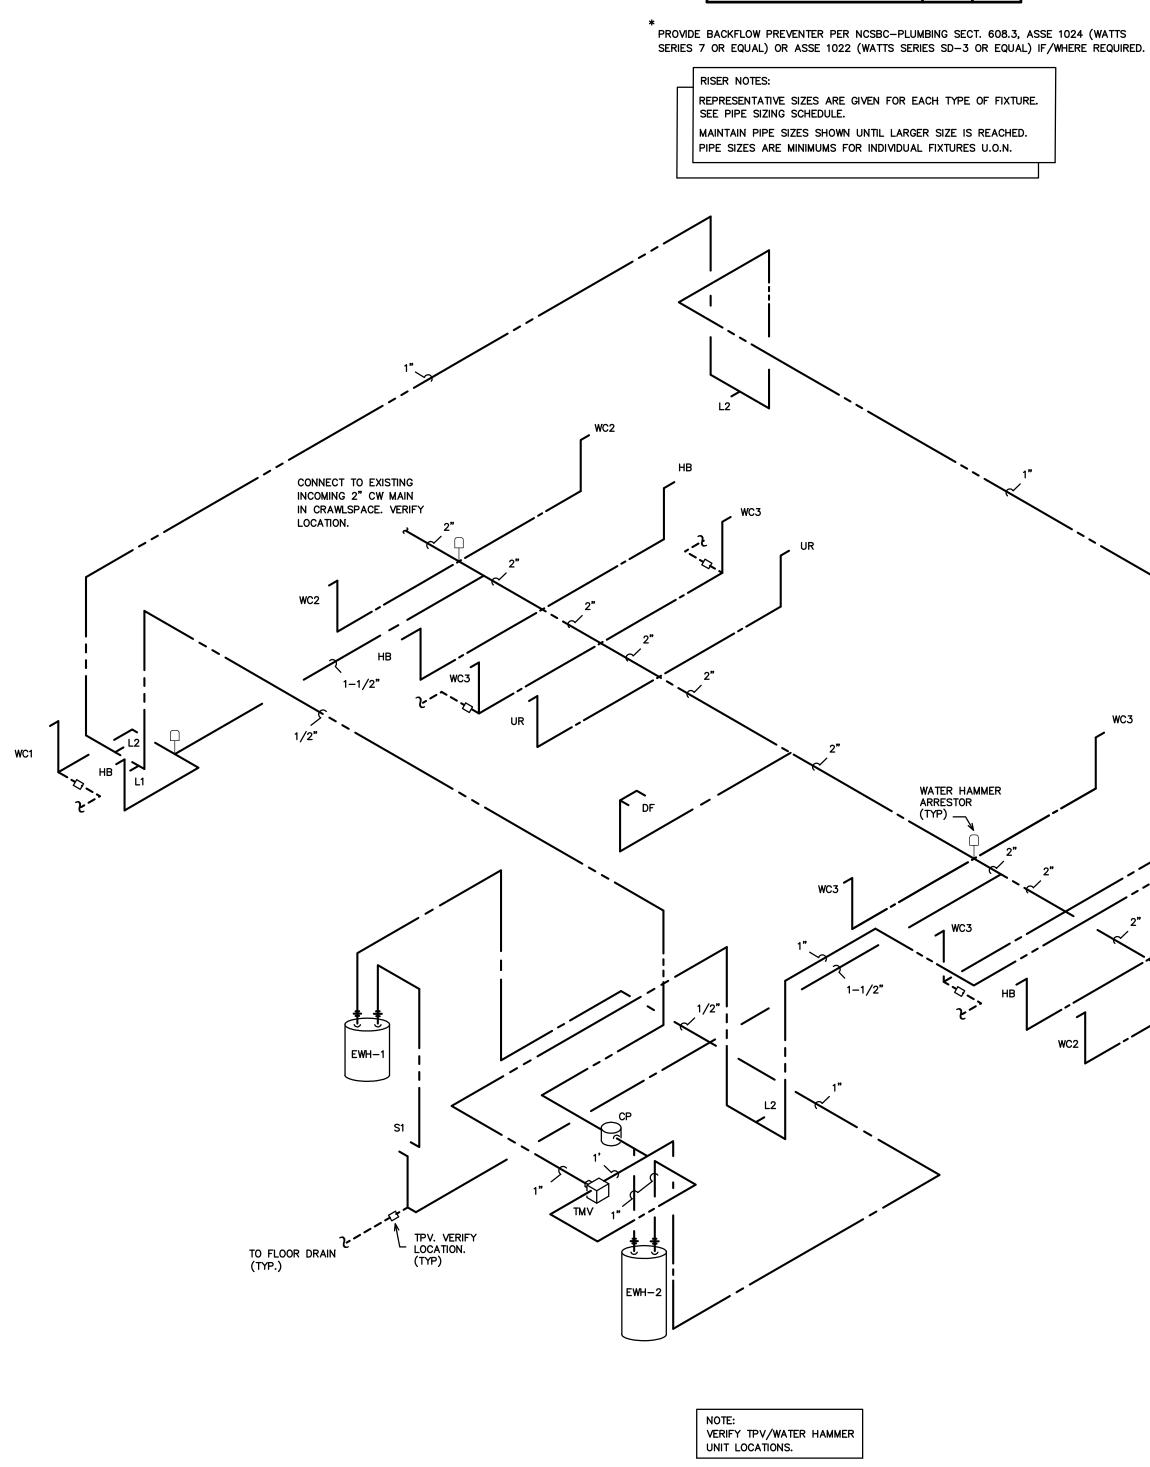
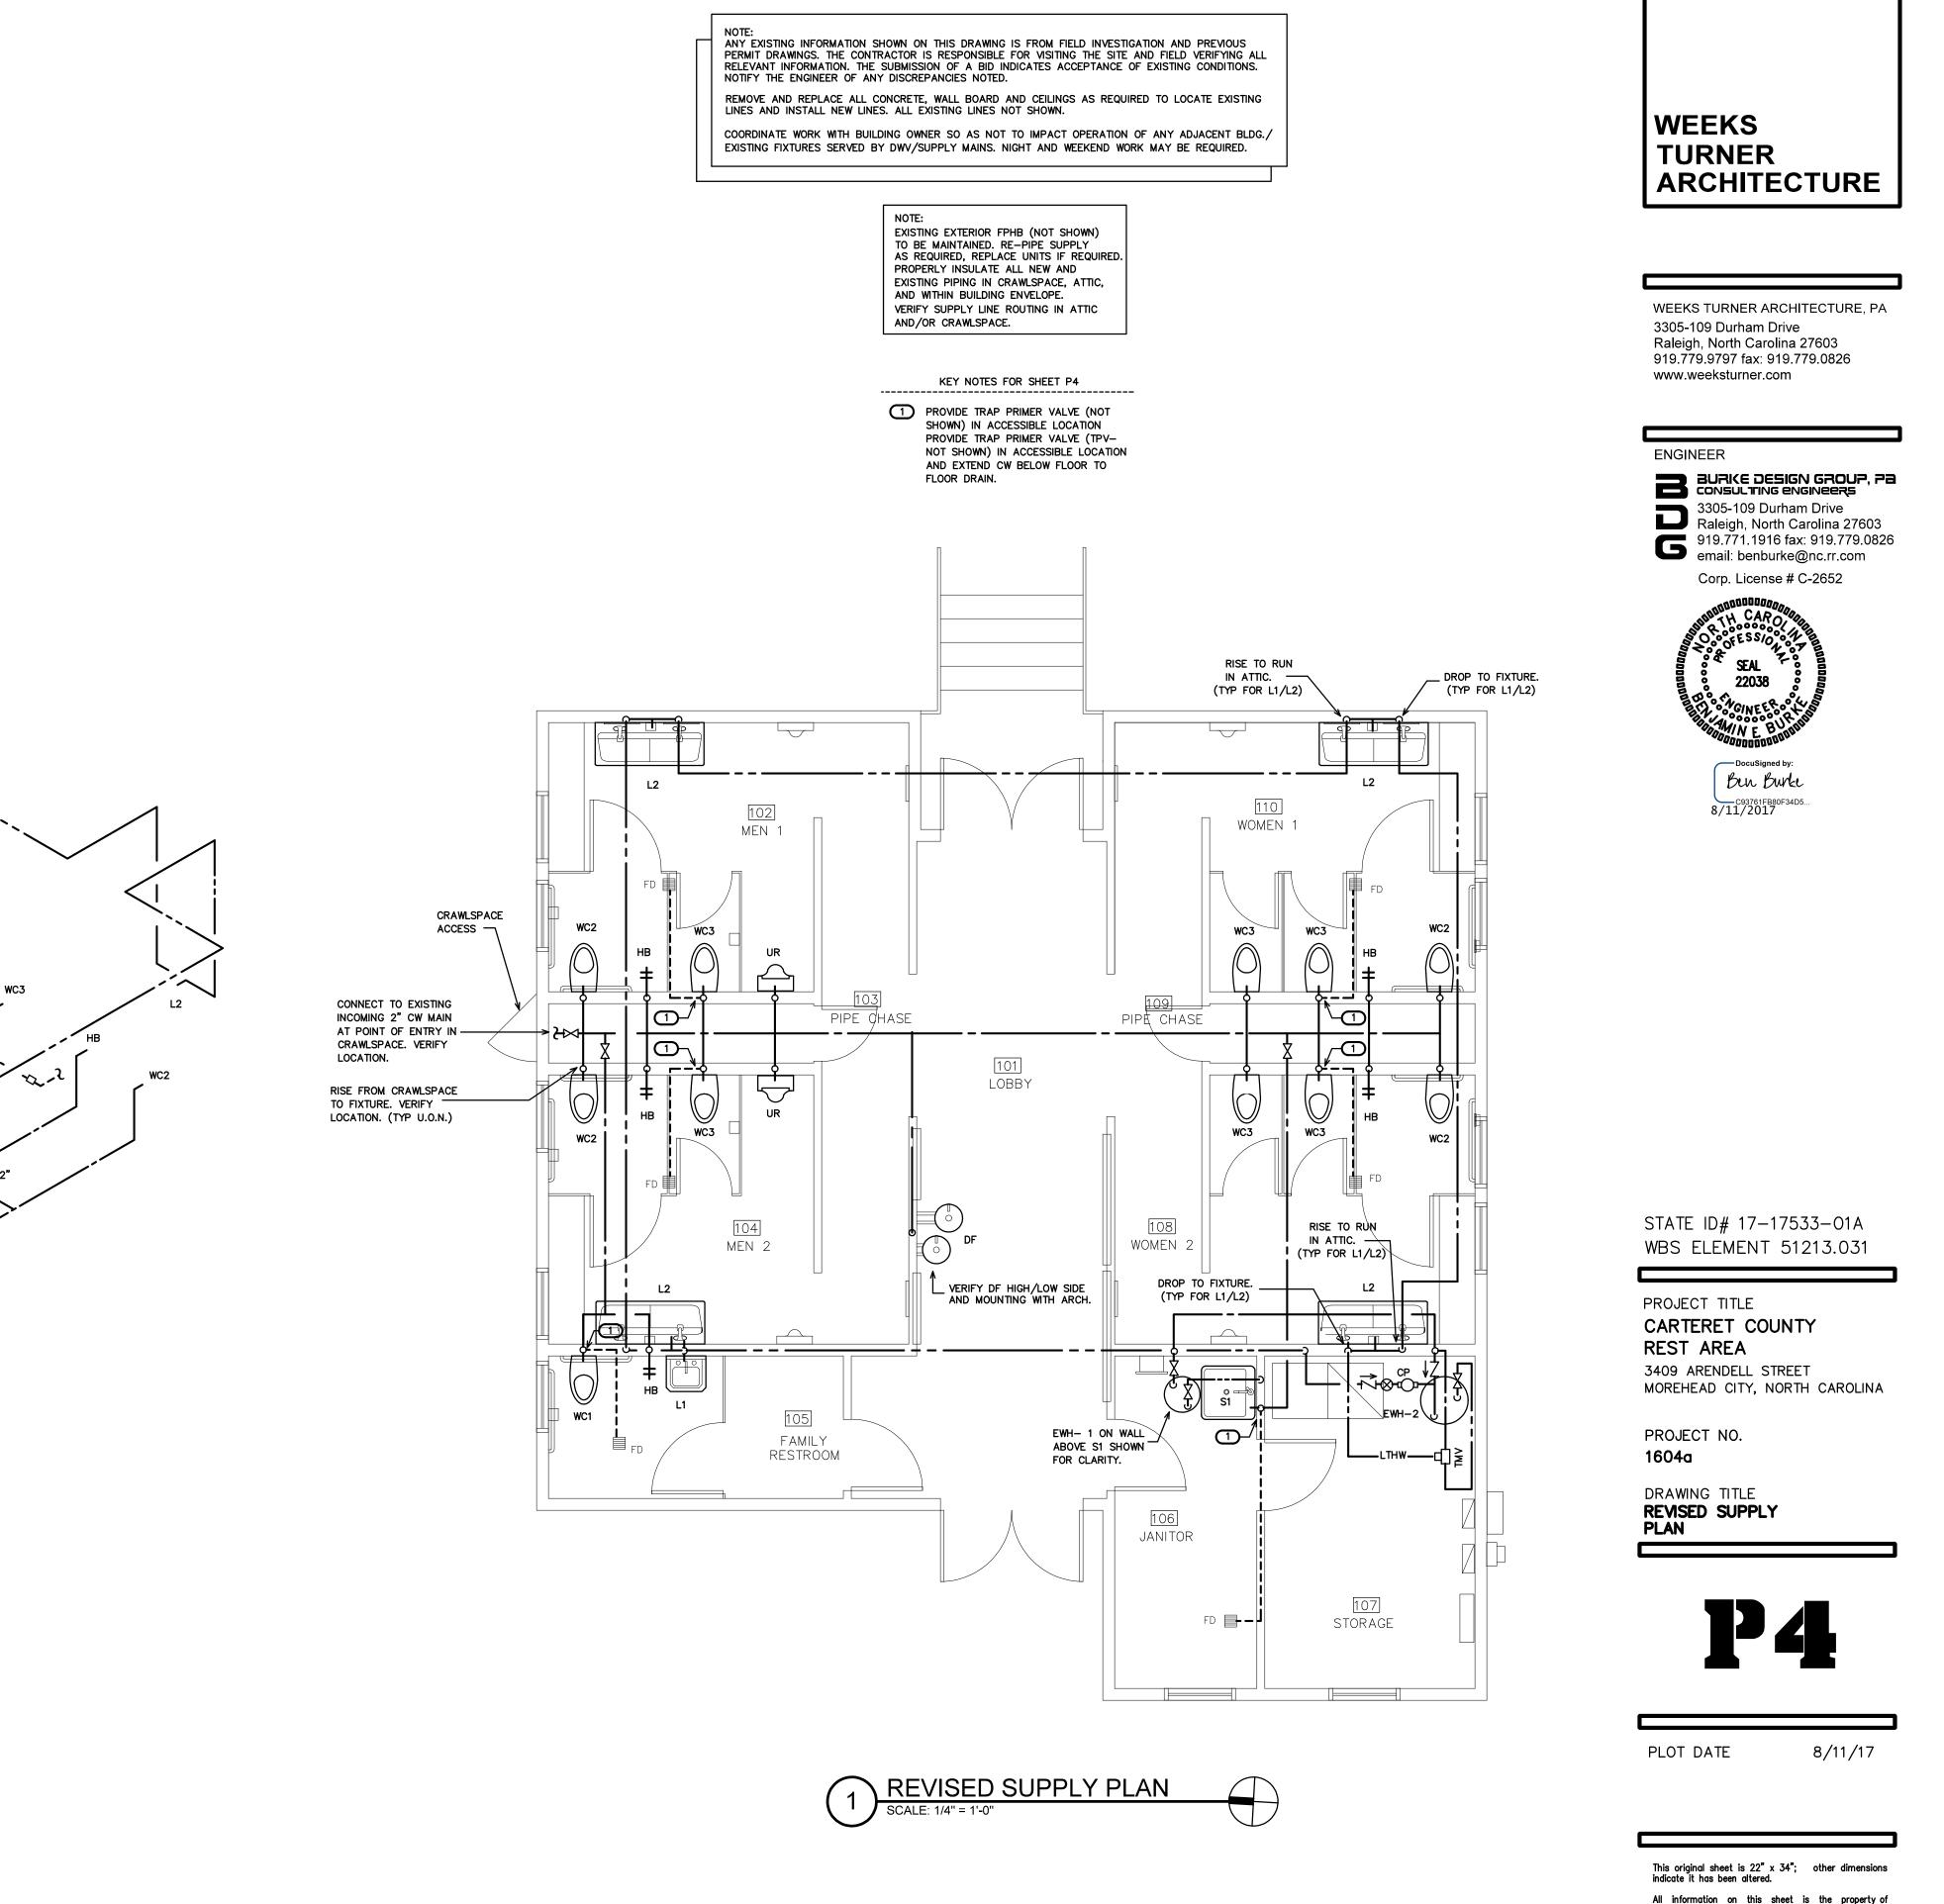
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